# HEBRON ELEMENTARY SCHOOL

92 CHURCH STREET
HEBRON, CT 06248
ROOF REPLACEMENT
STATE PROJECT NO. 067-0043 RR

PRE BID CONFORMANCE REVIEW 3/3/25

ISSUED TO BID 4/14/25

**ARCHITECT** 

FRIAR ARCHITECTURE
21 TALCOTT NOTCH ROAD
FARMINGTON, CONNECTICUT 06032

#### INDEX OF DRAWINGS

COVER SHEET

REFERENCE

R1.1 REFERENCE SHEET / CODE INFO

ARCHITECTURA

A0.1 ROOF KEY PLAN

D1.1 DEMO ROOF PLAN AREA B & AREA C

A1.1 FLOOR PLAN AREA B

A1.2 FLOOR PLAN AREA C

A2.1 CEILING PLAN AREA B

A2.2 CEILING PLAN AREA C

A3.1 ROOF PLAN AREA B
A3.2 ROOF PLAN AREA C

A4.1 ATTIC PLAN AREA C

A5.1 ROOF DETAILS

A5.2 ROOF DETAILS

A5.3 ROOF DETAILS

A5.4 ROOF DETAILS
A5.5 ROOF DETAILS

Rham High School 

Rham High School 

Ted's IGA Supermarket

Family Restaurant


Colebrook

Village at Hebron
Elementary School

Raymond Brook Preserve

Church of the Holy Family

SITE LOCATION MAP

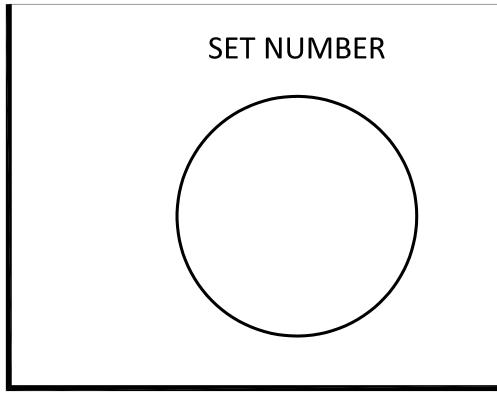

ABOVE FINISH FLOOR	A.F.F.	MASONRY	MAS.
ABOVE FINISH GRADE	A.F.G.	MASONRY OPENING	M.O.
ACOUSTIC	AC.	MATERIAL	MATL.
ACOUSTIC TILE	A.C.T.	MAXIMUM	MAX.
AIR CONDITIONING	A.C.	MECHANICAL	MECH.
AIR HANDLING UNIT	A.H.U.	METAL	MET.
ALTERNATE	ALT.	MEZZANINE	MEZZ.
ALUMINUM	ALUM.	MINIMUM	MIN.
ANCHOR, ANCHORAGE	ANCH.	MISCELLANEOUS	MISC.
ANCHOR BOLTS ANGLE	AB L		
ANODIZED	ANOD.	OFFICE	OFF.
APPROVED	APPD.	ON CENTER	O.C.
ARCHITECTURAL / ARCHITECT	ARCH.	OPPOSITE HAND	O.H.
ASBESTOS ASPHALT	ASB. ASPH.	OPENING	OPG.
ASSEMBLY	ASSY.	OUTSIDE DIAMETER	O.D.
ASSISTANT	ASST	OUTSIDE DIAINETEN	O.D.
AT AUTOMATIC	@ AUTO.		
AUTOMATIC	AUTU.	PAINTED	PTD.
BEAM	BM.	PAIR	PR.
BEARING	BRG.	PAPER TOWEL DISPENSER	P.T.D.
BETWEEN	BET.	PERPENDICULAR	PERP.
BEVEL / BEVELED BITUMINOUS	BEV. BIT.	PLASTER	PLAS.
BLOCK	BLK.	PLASTIC LAMINATE	P.LAM.
BLOCKING	BLKG.	PLATE	PL.
BOARD	BD.	PLUMBING	PLBG.
BOTTOM OF	В/О	PLYWOOD	PLYWD.
BOTTOM	BOTT.	PRECAST	P.C.
BUILDING	BLDG.	PREFABRICATED	PREFAB.
BUILT-UP ROOF	B.U.R.	PROJECT, PROJECTION	PROJ.
		POINT	PT.
CABINET	CAB.		
CABINET UNIT HEATER CAPACITY	C.U.H. CAP.	QUANTITY	QTY.
CAPACITY CEILING	CAP. CLG.	QUARRY TILE	Q.T.
CEILING HEIGHT	CLG. HGT.	RADIUS	RAD.
CEMENT	CEM.	RAIN WATER LEADER	RWL.
CENTER	CTR.	RECEIVING	RECV.
CENTERLINE CERAMIC	CL CT	REFRIGERATOR	REF.
CHALKBOARD	C.BD.	REINFORCED / REINFORCING	REINF.
CHANNEL	CH.	,	
CLOSET	CLOS.	REQUIRED  REVISION REVISED	REQ'D. REV.
COLUMN	COL.	REVISION, REVISED	
CONFERENCE	CONF.	RISER ROOF DRAIN	R
CONTROL OR			R.D.
CONSTRUCTION JOINT	C.J.	ROOM	RM.
CONTINUOUS	CONT.	SANITARY NAPKIN DISPENSER	S.N.D.
CONTRACTOR	CONTR.	SANITARY NAPKIN RECEPTACLE	S.N.R.
CORRIDOR	CORR.	SCHEDULE	SCHED.
COURSE / COURSES	CRS.	SCUPPER	SC.
DAMPPROOFING	DAMPR.	SECTION	SECT.
DEGREE	DEG.	SEISMIC JOINT	S.J.
DEMOLITION	DEMO.	SERVICE SINK	S.S.
DEPARTMENT	DEPT.	SHEET	SHT.
DETAIL	DET.	SIMILAR	SIM.
DIAMETER	DIA.	SOAP DISPENSER	S.D.
DIMENSION	DIM.	SOUND TRANSMISSION CLASS	S.T.C.
DISTANCE	DIST.		
DOOR	DIST. DR.	SPECIFICATIONS  SPLASH PLOCK	SPEC.
DOUBLE	DBL.	SPLASH BLOCK	S.B.
DOUBLE HUNG	DBL. D.H.	SQUARE	SQ.
DOMN DOORTE HONG	D.H. DN.	SQUARE INCH (S)	SQ.IN.
DOWN	DIN. D.S.	SQUARE YARD (S)	SQ.YD.
DOWNSPOUT DRAWING	D.S. DWG.	SQUARE FEET (FOOT)	S.F.
DRAWING DRINKING FOUNTAIN	DWG. D.F.	STAINLESS STEEL	ST. STL.
MINIMU FOUNTAIN	<i>∪</i> .1.	STANDARD	STD.
EACH	EA.	STEEL	STL.
ELECTRIC / ELECTRICAL	ELEC.	STORAGE	STOR.
ELECTRIC WATER COOLER	EWC.	STRUCTURAL	STRUCT.
ELEVATION	EL.	STRUCTURAL GLAZED FACING TILE	SGFT.
ELEVATION	ELEV.	STRUCTURAL STEEL.	STRUCT. S
EXISTING FIRE EXTINGUISHER	EXFE	SUSPEND, SUSPENSION	SUSP.
EMERGENCY	EMG.	SURFACE	SURF.
EQUAL	EQ.	SYSTEM	SYS.
EQUIPMENT	EQUIP.		
EXISTING	EXIST.		
EXISTING EXISTING TO REMAIN	EXIST. ETR.	TACKBOARD	T.BD.
	ETK. EXP.	TELEPHONE	TEL.
EXPANSION IOINT	EXP. E.J.	TEMPERATURE/TEMPORARY	TEMP.
EXPANSION JOINT		TONGUE & GROOVE	T & G
EXTERIOR INSLITATION	EXT.	THRESHOLD	THLD.
EXTERIOR INSULATION	FIEC	THICK	THK.
FINISH SYSTEM	EIFS.	TOILET	TLT
		TOP OF	T/O
EQUIPMENT	EQUIP.	TREAD	1/0 T.
EXISTING	EXIST.	TYPICAL	TYP.
EXISTING TO REMAIN	ETR.	TIFICAL	IYP.
EXPANSION	EXP.	UNDERWRITER'S LABORATORIES	U.L.
EXPANSION JOINT	E.J.	UNIT HEATER	U.L. U.H.
FFFT F0.2T		UNIT VENTILATOR	U.V.
FEET, FOOT	FT.	UNLESS NOTED OTHERWISE	U.N.O.
FINISH, FINISHED	FIN.	URINAL	UR.
FIRE DAMPER	FDR.		
FIRE EXTINGUISHER	FE.		
FIRE BANNEN  FIRE EXTINGUISHER  FIRE RETARDANT  FIREPROOFING	FE. FR. FPRFG.	VENT THRU ROOF	V.T.R.

VERIFY IN FIELD

WATER CLOSET

WHITE BOARD

WOOD

WATERPROOFING

WELDED WIRE FABRIC

VINYL ASBESTOS TILE

VINYL COMPOSITION TILE

VERTICAL

FIXT.

FLASH.

FLR. FIN.

FTG.

FDN.

FURN.

FURR.

GA.

GALV. GYP.BD.

HGT.

HORIZ.

IN. OR "

I.D. INSUL.

LAB.

LAV.

LTG.

MACH.

MAINT. MFR.

V.I.F.

VERT.

V.A.T.

V.C.T.

W.W.F.

WBD.

FIREPROOFING

FIXTURE

FLASHING

FLOOR DRAIN

FLOOR FINISH

FOUNDATION

GALVANIZED

HANDRAIL HANDICAPPED HEIGHT

HIGH POINT

HOSE BIB

HOLLOW METAL HORIZONTAL

INCH OR INCHES

INFORMATION

INSULATION

INTERIOR

KICKPLATE

LABORATOR

LAVATORY

LIGHTING

MACHINE

MAINTENANCE

MANUFACTURER MARKER BOARD

INSIDE DIAMETER

INCLUDE / INCLUDING

GYPSUM BOARD

FURNISH / FURNISHED

FURRED / FURRING

FOOTING.

GAUGE

FLOOR

#### SYMBOLS LEGEND

ARCHITECTURAL SYM	BOLS
BUILDING SECTION	SECTION NUMBER SHEET NUMBER
WALL SECTION	SECTION NUMBER SHEET NUMBER
COLUMN CENTERLINE	NUMBERS - (VERT.)  LETTERS - (HORIZ.)
DETAIL DESIGNATION, PLAN DETAIL, LARGE SCALE PLANS	DETAIL NUMBER SHEET NUMBER
INTERIOR ELEVATIONS	ELEVATION NUMBER  SHEET NUMBER
CASEWORK ELEVATIONS	ELEVATION NUMBER
CEILING DESIGNATION	CEILING TYPE (LETTER)  CEILING HEIGHT (NUMBER)
ROOM NUMBER	• NUMBER
DOOR NUMBER	NUMBER/TYPE
WINDOW DESIGNATION	LETTER/TYPE
DEMOLITION TAG	NUMBER
WALL TYPES	NUMBER
PHOTO LOCATION	PHOTO NUMBER
REVISION NUMBER	NUMBER
DATUM / ELEVATION / LEVEL LINE	
EXISTING CONSTRUCTION TO REMAIN	
NEW STUD CONSTRUCTION	<u> </u>
NEW CONCRETE BLOCK	
NEW FACE BRICK	<u> </u>
SOFFITS / OVERHANG ABOVE	
AREA OF REFUGE WHEELCHAIR SPACE ACCESS. CLEAR FLOOR SPACE ASSEMBLY WHEELCHAIR SEAT	

ASSEMBLY WHEELCHAIR SEAT 30"x48" CLEAR FLOOR SPACE

ACCESSIBLE ELEMENT

ARCHITECTU	JRAL MATERI	ALS	
ACOUSTICAL TILE		PLASTER	
ALUMINUM			
BATT INSULATION		PLYWOOD (SMALL)	
BITUMINOUS		RIGID INSULATION	
BRASS OR BRONZE		ROUGH WOOD (CONTINUOUS)	
CARPET		ROUGH WOOD (INTERRUPTED)	
CAST STONE		RUBBLE	
CERAMIC TILE		SHEATHING INSUL.	
C.M.U.		SLATE, FLAGGING, SOAPSTONE	
CONCRETE	4	STEEL	
EARTH		STRUCTURAL CLAY	
FACE BRICK		STRUCT. GLAZED FACING TILE	
FACE GRAIN		TERRA-COTTA	
FINISHED WOOD		TERRAZZO	A A A A A A A A A A A A A A A A A A A
FIRE BRICK		ELEVATIONS	
GLASS BLOCK		BRICK	
GLAZED BRICK (CALL OUT)		CONCRETE BLOCK	
GLAZING		CERAMIC TILE	
GRAVEL		GLASS	11 11/11/11
GYPSUM BOARD		METAL PANEL	
MARBLE		CORRUGATED  SLATE, FLAGGING, SOAPSTONE	
METAL LATH		SHINGLES	
METAL (SMALL)		FLAT METAL PANEL	

#### CODE INFORMATION

#### **EXISTING BUILDING INFORMATION**

Da	te of Original Construction 1968 Additions / Renovation	ns 1970's - Additions & Alterations 1980's - Additions & Alterations 1998 - Additions & Alterations
1.	GROUP CLASSIFICATION (Primary)	E, EDUCATIONAL
2.	CONSTRUCTION TYPE	
	Actual Type Provided	5A / 2B
	New Construction	None
3.	WORK AREA (WORK AREA) Existing Roof Area to be Replaced	27,654 s.f.
4.	FIRE-RESISTANCE RATED REQUIREMENTS FOR BUILDING ELEMENTS (	Table 705.5)
	Primary structural frame	2B 0 Hr(s)
	Bearing walls: Exterior Interior	0 Hr(s) See Table 705.5 0 Hr(s)
	Nonbearing walls and partitions (Exterior)	- Hr(s) See Table 705.5
	Nonbearing walls and partitions (Interior)	O Hr(s)
	Floor Construction and associated secondary members	0 Hr(s)
	Roof Construction and associated secondary members	0 Hr(s)
5.	SPRINKLER PROTECTION Provided X None Provided	Refer to Table 705.5 for all footnote

#### CODE INFORMATION

\* WITH CONNECTICUT AMENDMENTS AND GENERAL STATUTE REQUIREMENTS

EXISTING ROOF CONSTRUCTION 68,271 s.f.

EXISTING ROOF TO BE REPLACED 27,654 s.f.

6. BUILDING AREAS FOR GRANT CALCULATIONS (ENTIRE FACILITY)

EXISTING ROOF TO REMAIN

TOTAL ROOF - ENTIRE FACILITY

2021 INTERNATIONAL RESIDENTIAL CODE \* 2021 INTERNATIONAL BUILDING CODE \* 2021 INTERNATIONAL EXISTING BUILDING CODE \* 2021 INTERNATIONAL MECHANICAL CODE \* 2017 ACCESSIBLE AND USABLE BUILDINGS AND

FACILITIES (ICC A117.1-2017) \*

2021 INTERNATIONAL PLUMBING CODE \* 2021 INTERNATIONAL ENERGY CONSERVATION CODE \* 2020 NATIONAL ELECTRICAL CODE (NFPA 70) \* 2019 INSTALLATION OF SPRINKLER SYSTEMS (NFPA 13)

2021 INTERNATIONAL FIRE CODE \* 2021 LIFE SAFETY CODE (NFPA 101) \* 2021 INTERNATIONAL SWIMMING POOL & SPA CODE \*

2021 FIRE CODE (NFPA 1) \*

ROOF SYSTEM INFORMATION

#### STEEL ROOF DECK


ASPHALT SHINGLE ROOF SY	'STEM
MATERIAL:	'R' VALUE:
OUTSIDE AIR	0.17
ASPHALT SHINGLE ROOFING	0.44
ICE & WATER SHIELD	0.00
MINIMUM 4" VENTED COMPOSITE RIGID	
ROOF INSULATION (MIN. R = 5.7/INCH)	14.40
MINIMUM 2-1/2" CONTINUOUS RIGID	
ROOF INSULATION (MIN. R = 5.7/INCH)	14.40
5/8" ROOF BOARD	0.67
STEEL ROOF DECK	0.00
INSIDE AIR FILM	0.61
Total:	30.69
IECC 2021	30.00 C.I.

#### SHINGLE ROOF ASSEMBLY - STEEL DECK — ASPHALT SHINGLE ROOFING SYSTEM — ROOFING LEAK BARRIER - 4" COMPOSITE ROOFING INSULATION BOARD — 2.5" MINIMUM POLYISO RIGID ROOF INSULATION - 2.5" MINIMUM POLYISO RIGID ROOF INSULATION ─ 5/8" ROOF BOARD — EXISTING STEEL ROOF DECK DRAWING - NOT TO SCALE 5/8" ROOF BOARD TO FURNISHED & INSTALLED AT EXISTING 4" DEEP STEEL

**ROOF R-VALUES** 

#### STEEL ROOF DECK

EPDM ROOFING SYSTEN	1
MATERIAL:	'R' VALUE:
OUTSIDE AIR	.17
EPDM ROOF MEMBRANE	0.50
1/2" HIGH R COVER BOARD	2.50
MINIMUM 5" CONTINUOUS RIGID	28.50
ROOF INSULATION (MIN. R = 5.7/INCH)	
STEEL ROOF DECK / VAPOR BARRIER	0.00
INSIDE AIR FILM	0.61
Total:	32.28
IECC 2021	30 C.I.
_	_

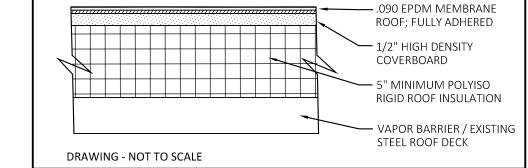


5/8" ROOF BOARD TO FURNISHED & INSTALLED AT EXISTING 4" DEEP STEEL

EPDM ROOF ASSEMBLY - STEEL DECK


#### WOOD (TRUSS) ROOF DECK

ASPHALT SHINGLE ROOF S	TSTEIVI
MATERIAL:	'R' VALUE:
OUTSIDE AIR	0.17
ASPHALT SHINGLE ROOFING	0.44
ICE & WATER SHIELD	0.00
EXISTING 3/4" PLYWOOD ROOF DECK	0.94
2" CONTINUOUS MINERAL WOOL	
INSULATION	8.60
EXISTING TRUSS ROOF INSULATION	
12" BATT ROOF INSULATION	38.00
EXISTING 1-LAYER 5/8" TYPE X GYP. BD.	0.56
INSIDE AIR FILM	0.61
Total:	49.32
IECC 2021	49.00

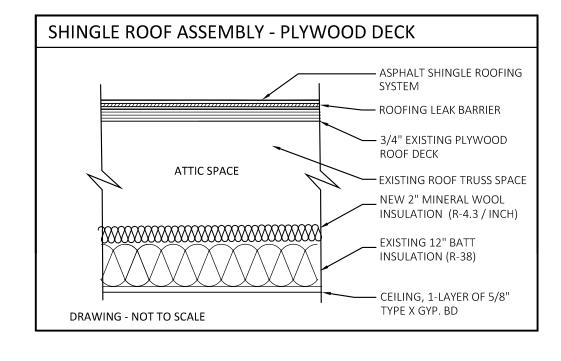

#### WOOD (TRUSS) ROOF DECK

EPDM ROOFING SYSTI	ΞM
MATERIAL:	'R' VALUE:
OUTSIDE AIR	0.17
EPDM ROOF MEMBRANE	0.50
5/8" ROOF BOARD	0.67
EXISTING 3/4" PLYWOOD ROOF DECK	0.94
2" CONTINUOUS MINERAL WOOL	
INSULATION	8.60
EXISTING TRUSS ROOF INSULATION	
12" BATT ROOF INSULATION	38.00
1-LAYER 5/8" TYPE X GYP. BD.	0.56
INSIDE AIR FILM	0.61
Total:	50.05
IECC 2021	49.00

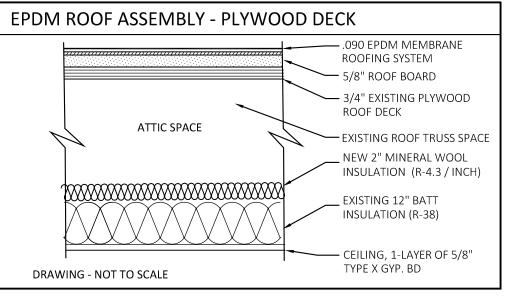

#### ROOF REPLACEMENT - CODE INFO

THE INTERNATIONAL EXISTING BUILDING CODE (IEBC)

CHAPTER 3: PROVISIONS FOR ALL COMPLIANCE METHODS

SECTION 301 ADMINISTRATION - IN PARTICULAR SECTIONS 301.1 APPLICABILITY, AND WORK AREA COMPLIANCE METHOD PER SECTION 301.3.2

CHAPTER 6: CLASSIFICATION OF WORK -SECTION 602 ALTERATION LEVEL 1 - 602.1 SCOPE, REFERS TO THE REMOVAL AND REPLACEMENT OR THE COVERING OF EXISTING MATERIALS (ROOF REPLACEMENT). THE SCOPE OF WORK AREA IS AN ALTERATION LEVEL 1

602.2 APPLICATION - LEVEL 1 ALTERATIONS SHALL COMPLY WITH THE PROVISIONS OF CHAPTER 7: ALTERATIONS - LEVEL 1

THE ALTERATION MUST COMPLY WITH CHAPTER 7: SECTION 701 GENERAL - IN PARTICULAR SECTION 701.2 CONFORMANCE.

SECTION 702 BUILDING ELEMENTS AND MATERIALS - IN PARTICULAR SECTIONS 702.7 MATERIALS AND METHODS

SECTION 705 REROOFING - IN PARTICULAR SECTIONS 705.1 GENERAL, 705.2 ROOF REPLACEMENT& 705.5 FLASHINGS

SECTION 706 STRUCTURAL - IN PARTICULAR SECTIONS 706.1 GENERAL, SECTION 706.2 ADDITION OR REPLACEMENT OF ROOFING OR REPLACEMENT OF EQUIPMENT, SECTION 706.3 ADDITIONAL REQUIREMENTS FOR REROOF PERMITS

SECTION 708 ENERGY CONSERVATION - 708.1 MINIMUM REQUIREMENTS

SECTION 708 ENERGY CONSERVATION - IN PARTICULAR SECTION 708.1 MINIMUM REQUIREMENTS

LEVEL 1 ALTERATIONS TO EXISTING BUILDINGS OR STRUCTURES DO NOT REQUIRE THE ENTIRE BUILDING OR STRUCTURE TO COMPLY WITH THE ENERGY REQUIREMENTS OF THE INTERNATIONAL ENERGY CONSERVATION CODE OR INTERNATIONAL RESIDENTIAL CODE. THE ALTERATIONS SHALL CONFORM TO THE ENERGY REQUIREMENTS OF THE INTERNATIONAL ENERGY CONSERVATION CODE OR INTERNATIONAL RESIDENTIAL CODE AS THEY RELATE TO NEW CONSTRUCTION ONLY.

BY COMPLYING WITH THE APPLICABLE REQUIREMENTS OF CHAPTERS 7 OF THE 2021 INTERNATIONAL EXISTING BUILDING CODE (IEBC) THIS ALTERATION SHALL BE CONSIDERED IN COMPLIANCE.



PROFESSIONAL SEAL

CONSULTANT

ROOF REPLACEMENT

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### REFERENCE SHEET CODE INFORMATION

SCALE: NOT TO SCALE PROJ. #: 2024-022A DRAWN:\_

SHEET NO.

CHECKED:\_ RWR


#### ROOF WIND LOADING


WIND CODE DATA	
CLIMATE ZONE WIND SPEED - Ultimate Design Vult WIND SPEED - Nominal Design Vasd Wind-Bourne Debris Region	5 130 mph 101 mph Type C
SURFACE ROUGHNESS EXPOSURE CATEGORY RISK CATEGORY Ground Snow Load (psf) Seismic Design Category Hurricane-Prone Regions	B III 30 B Yes

#### BUILDING ENVELOPE REQUIREMENTS

IECC 2006 TABLE 802.2(1) - ZONE 5 AND MARINE 4

ELEMENT	MINIMUM REQUIRED CONDITION/VALUE
ROOFS	
INSULATION ENTIRELY ABOVE DECK	R-30 C.I.
ATTIC AND OTHER	R-49

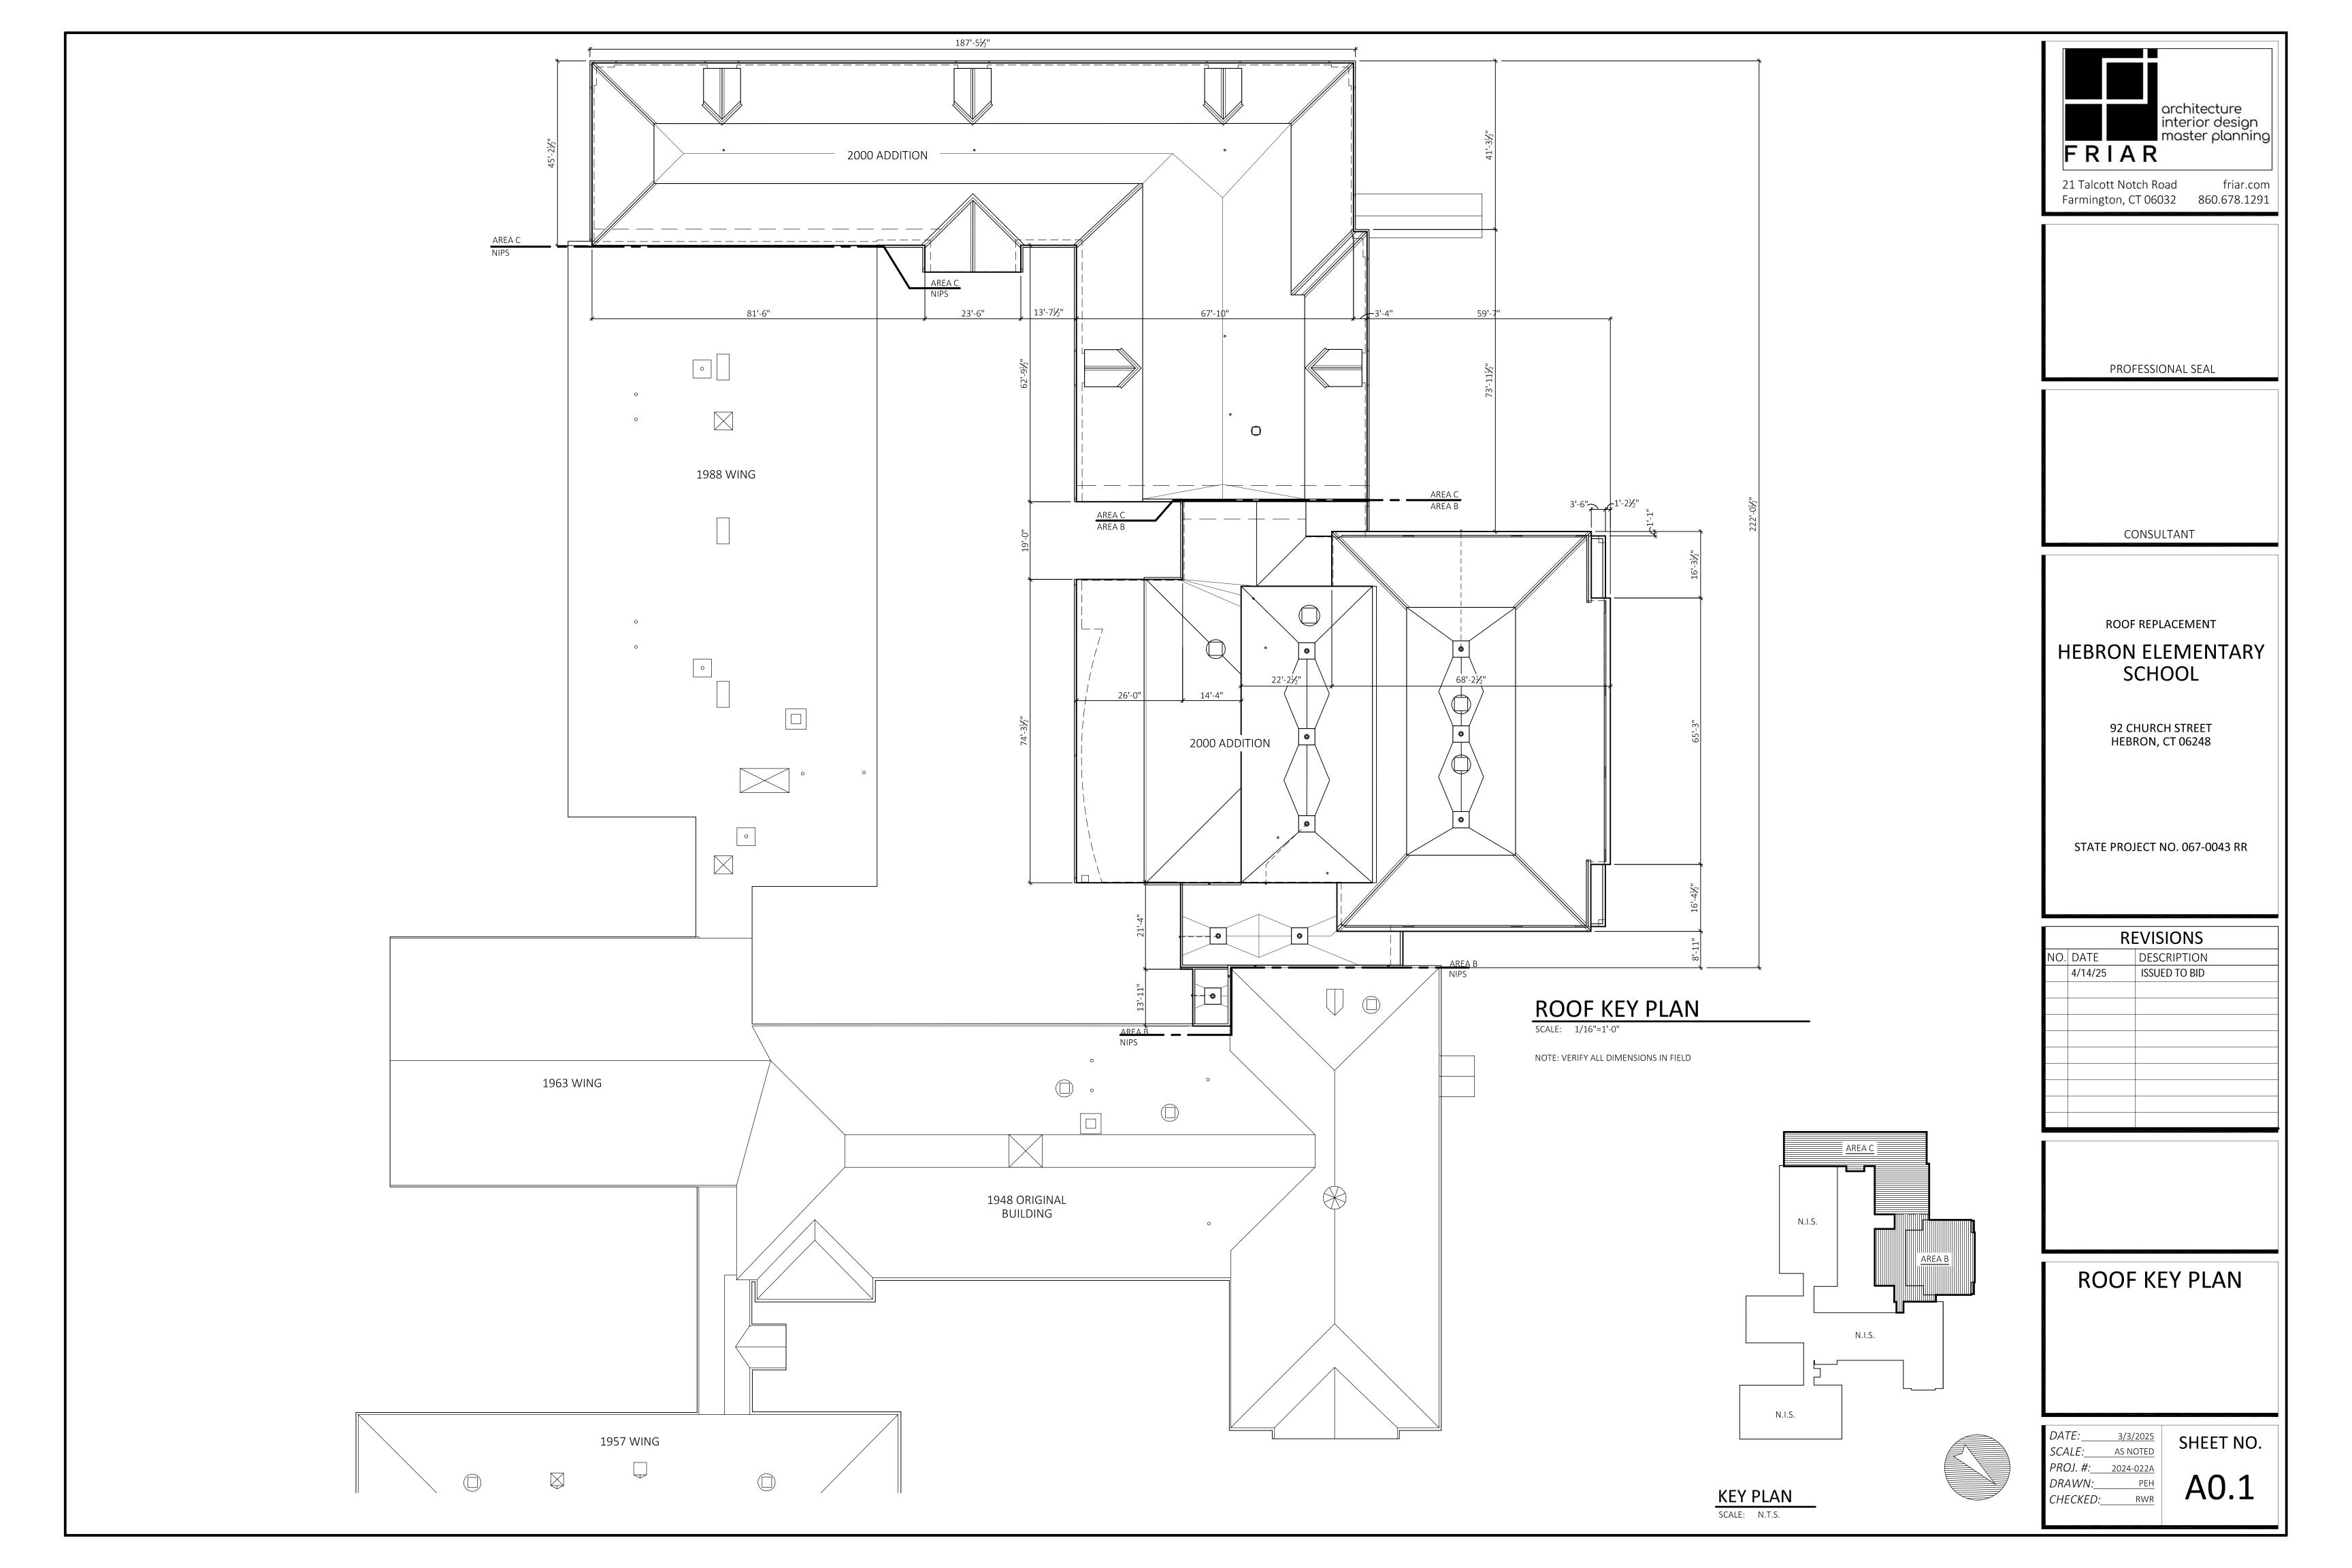

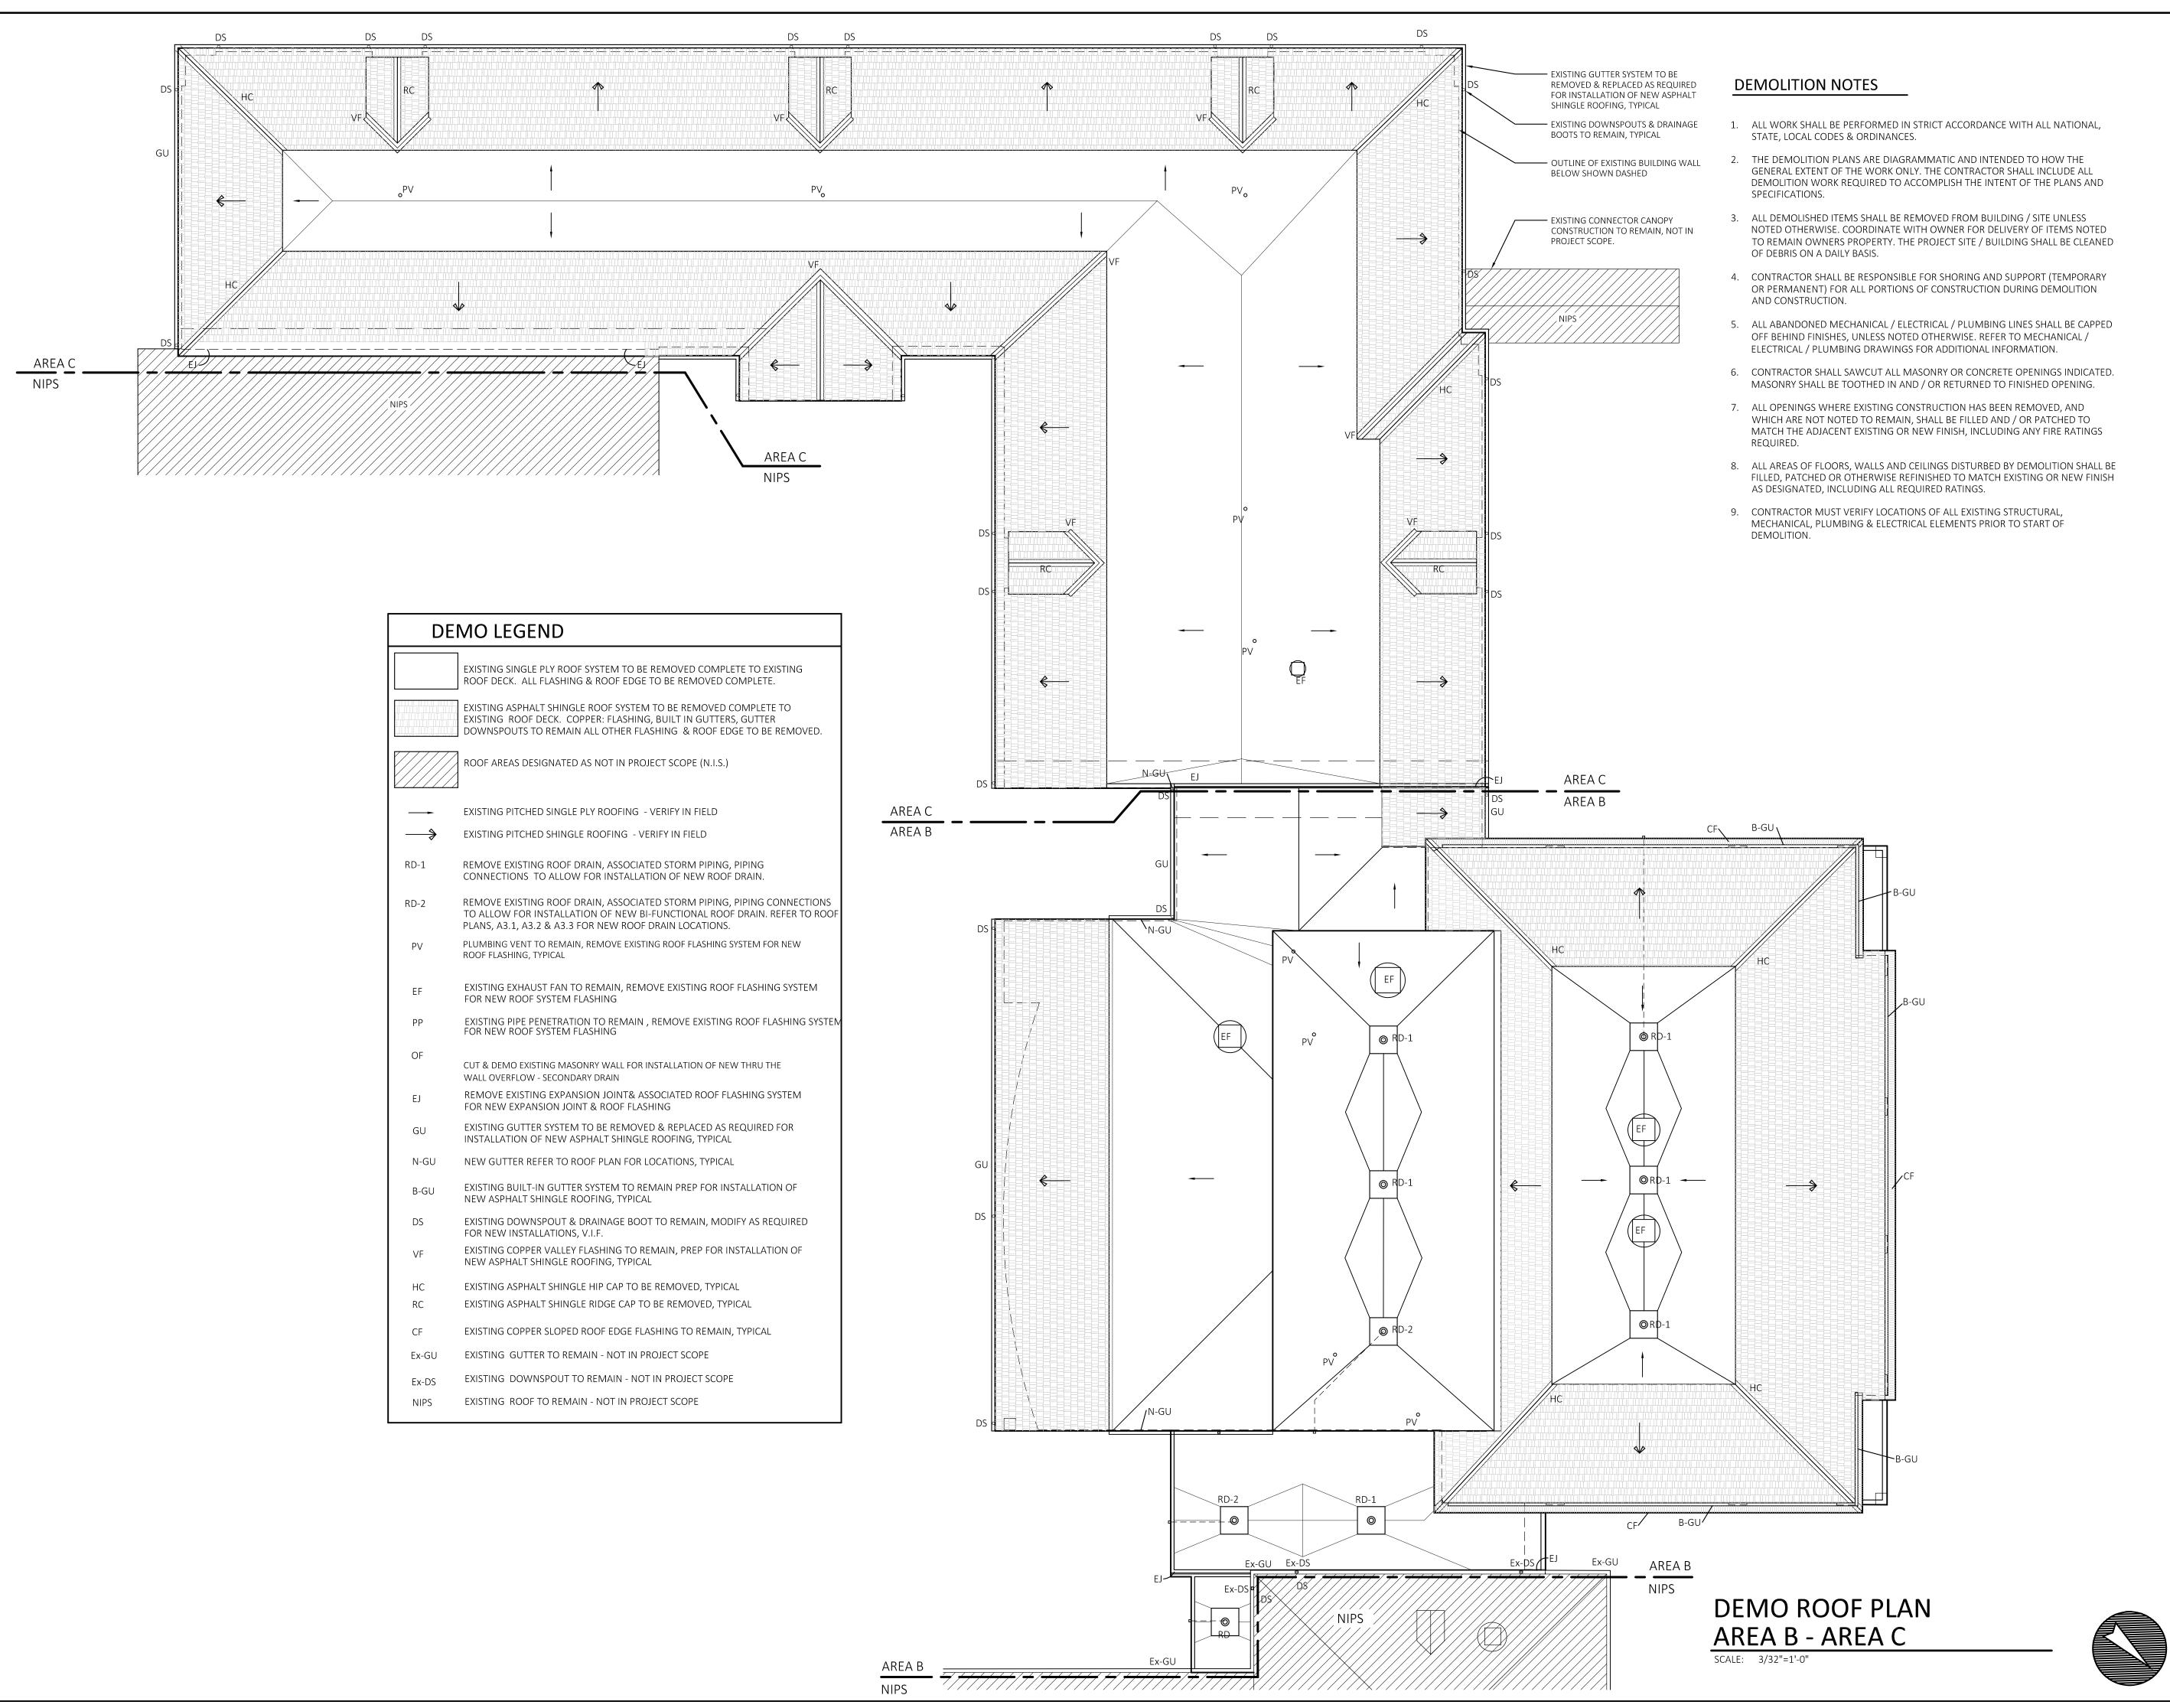



Farmington, CT 06032 860.678.1291

PROFESSIONAL SEAL

CONSULTANT

ROOF REPLACEMENT

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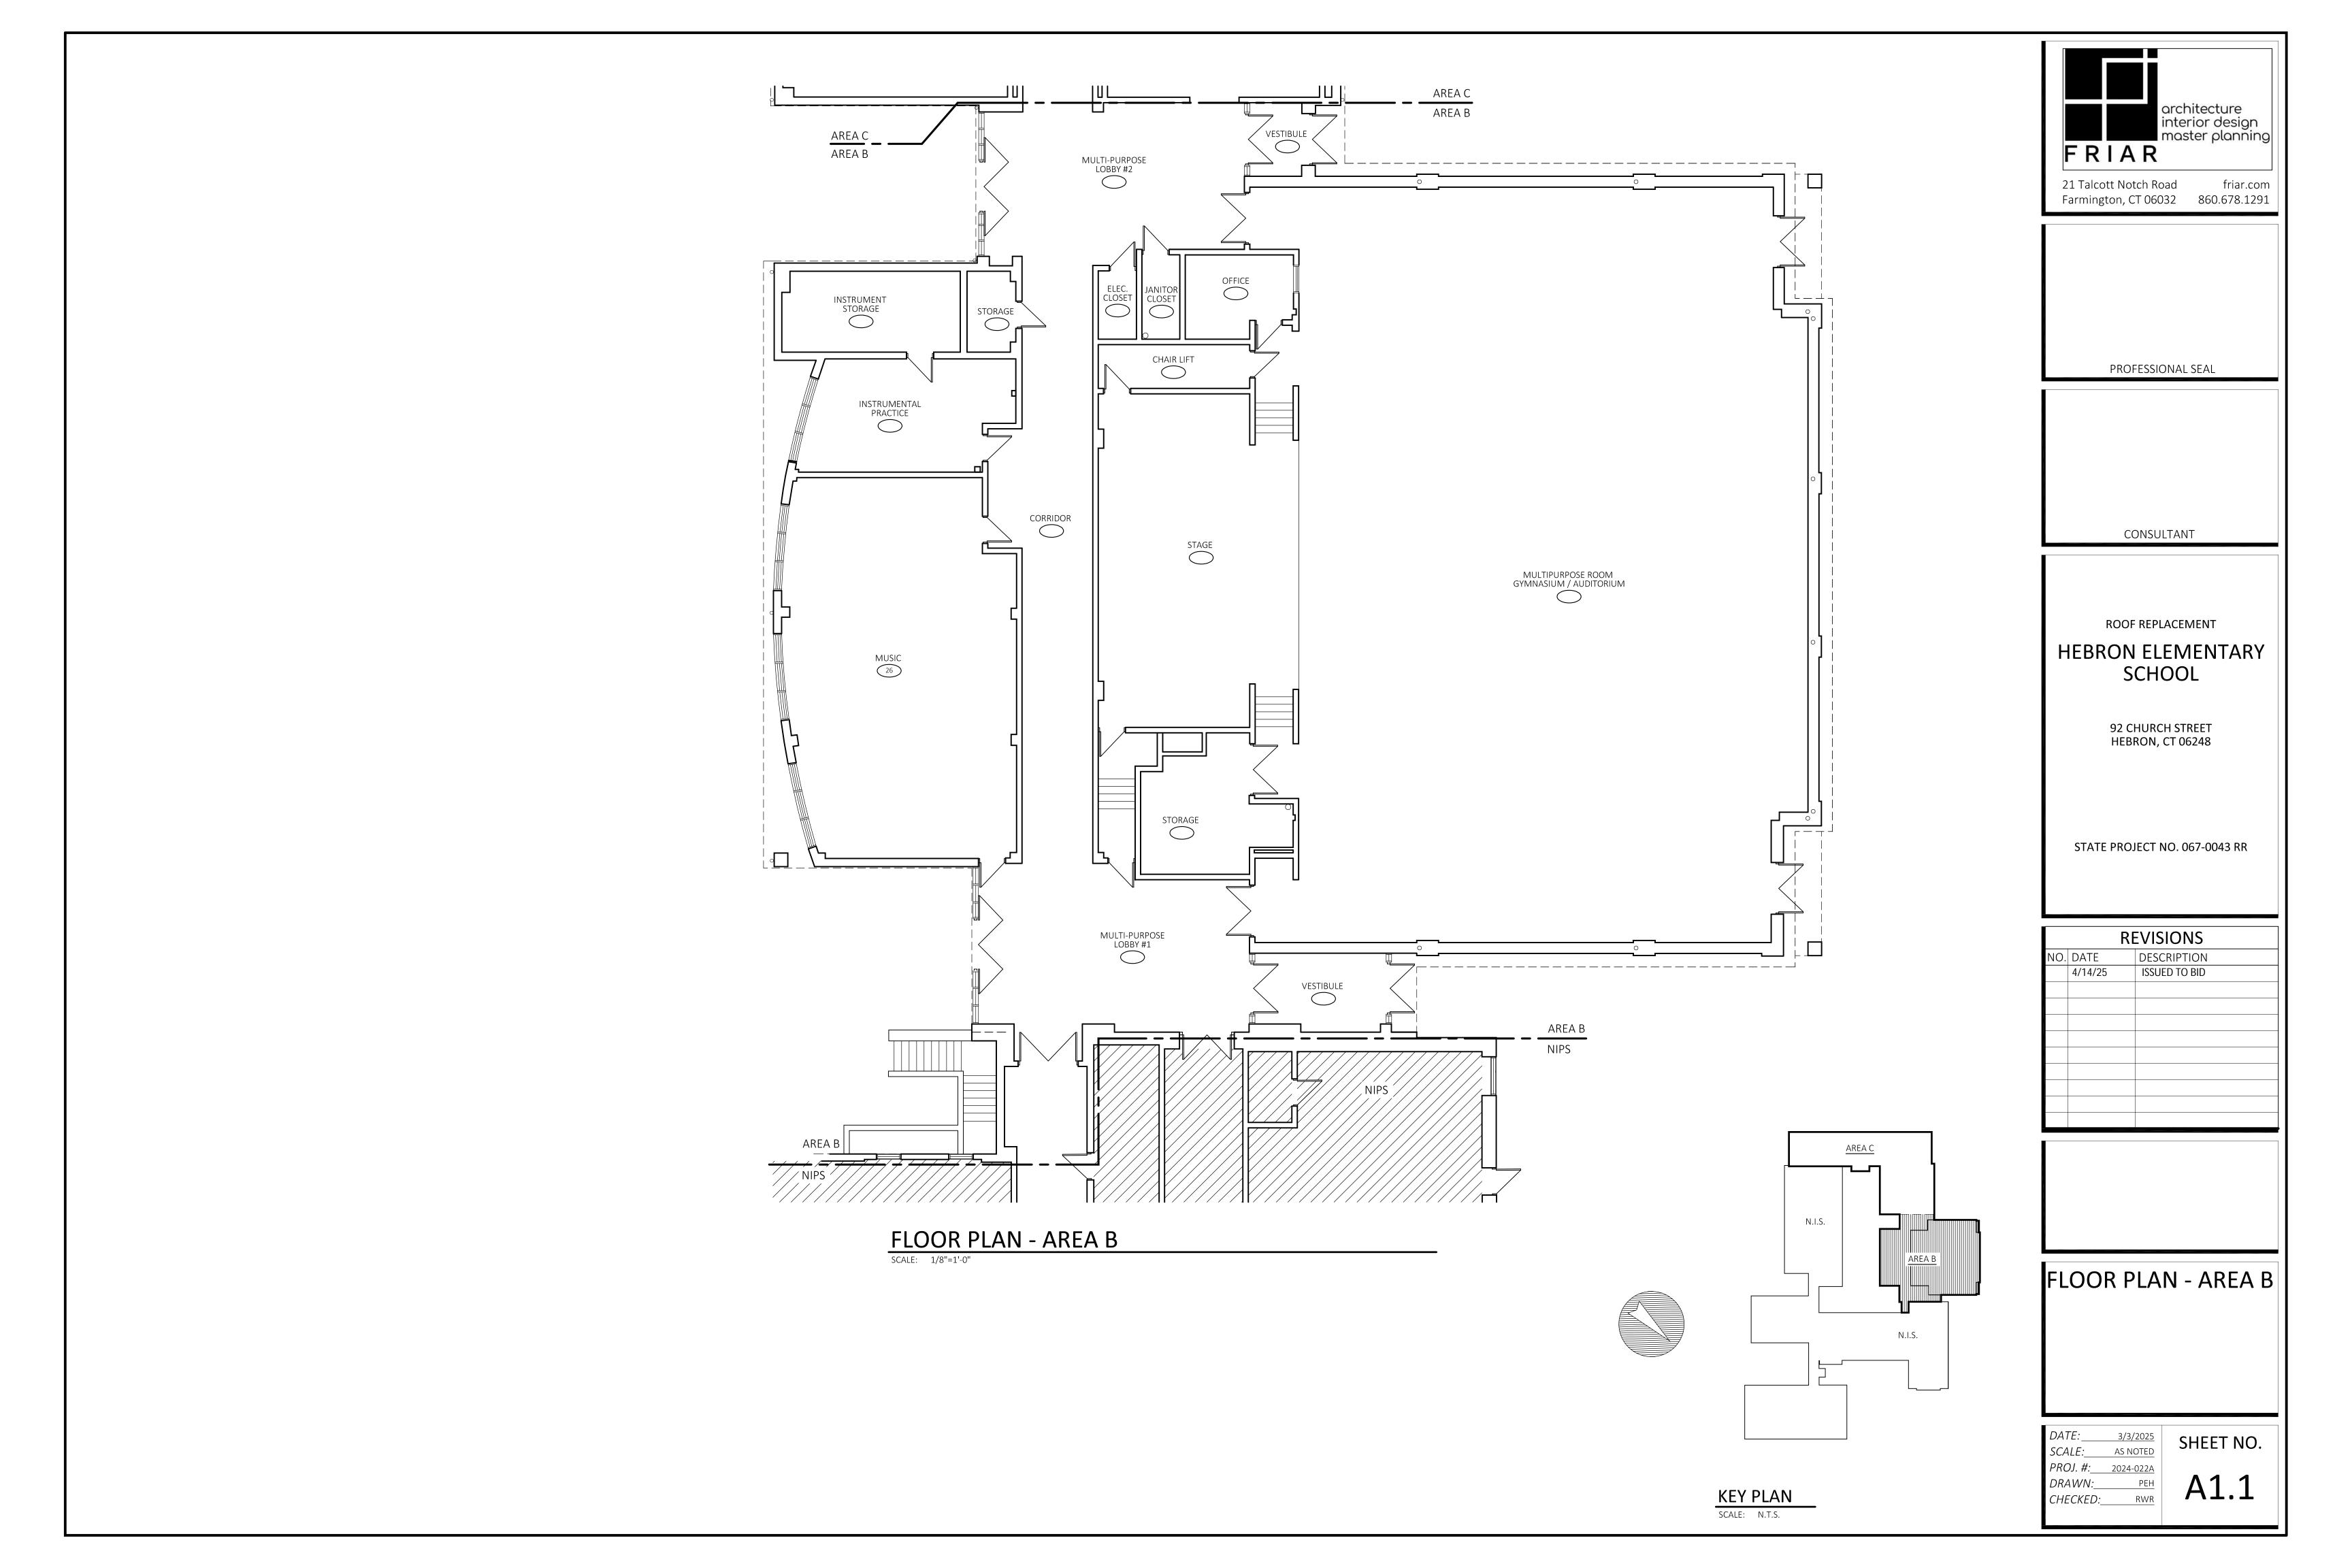
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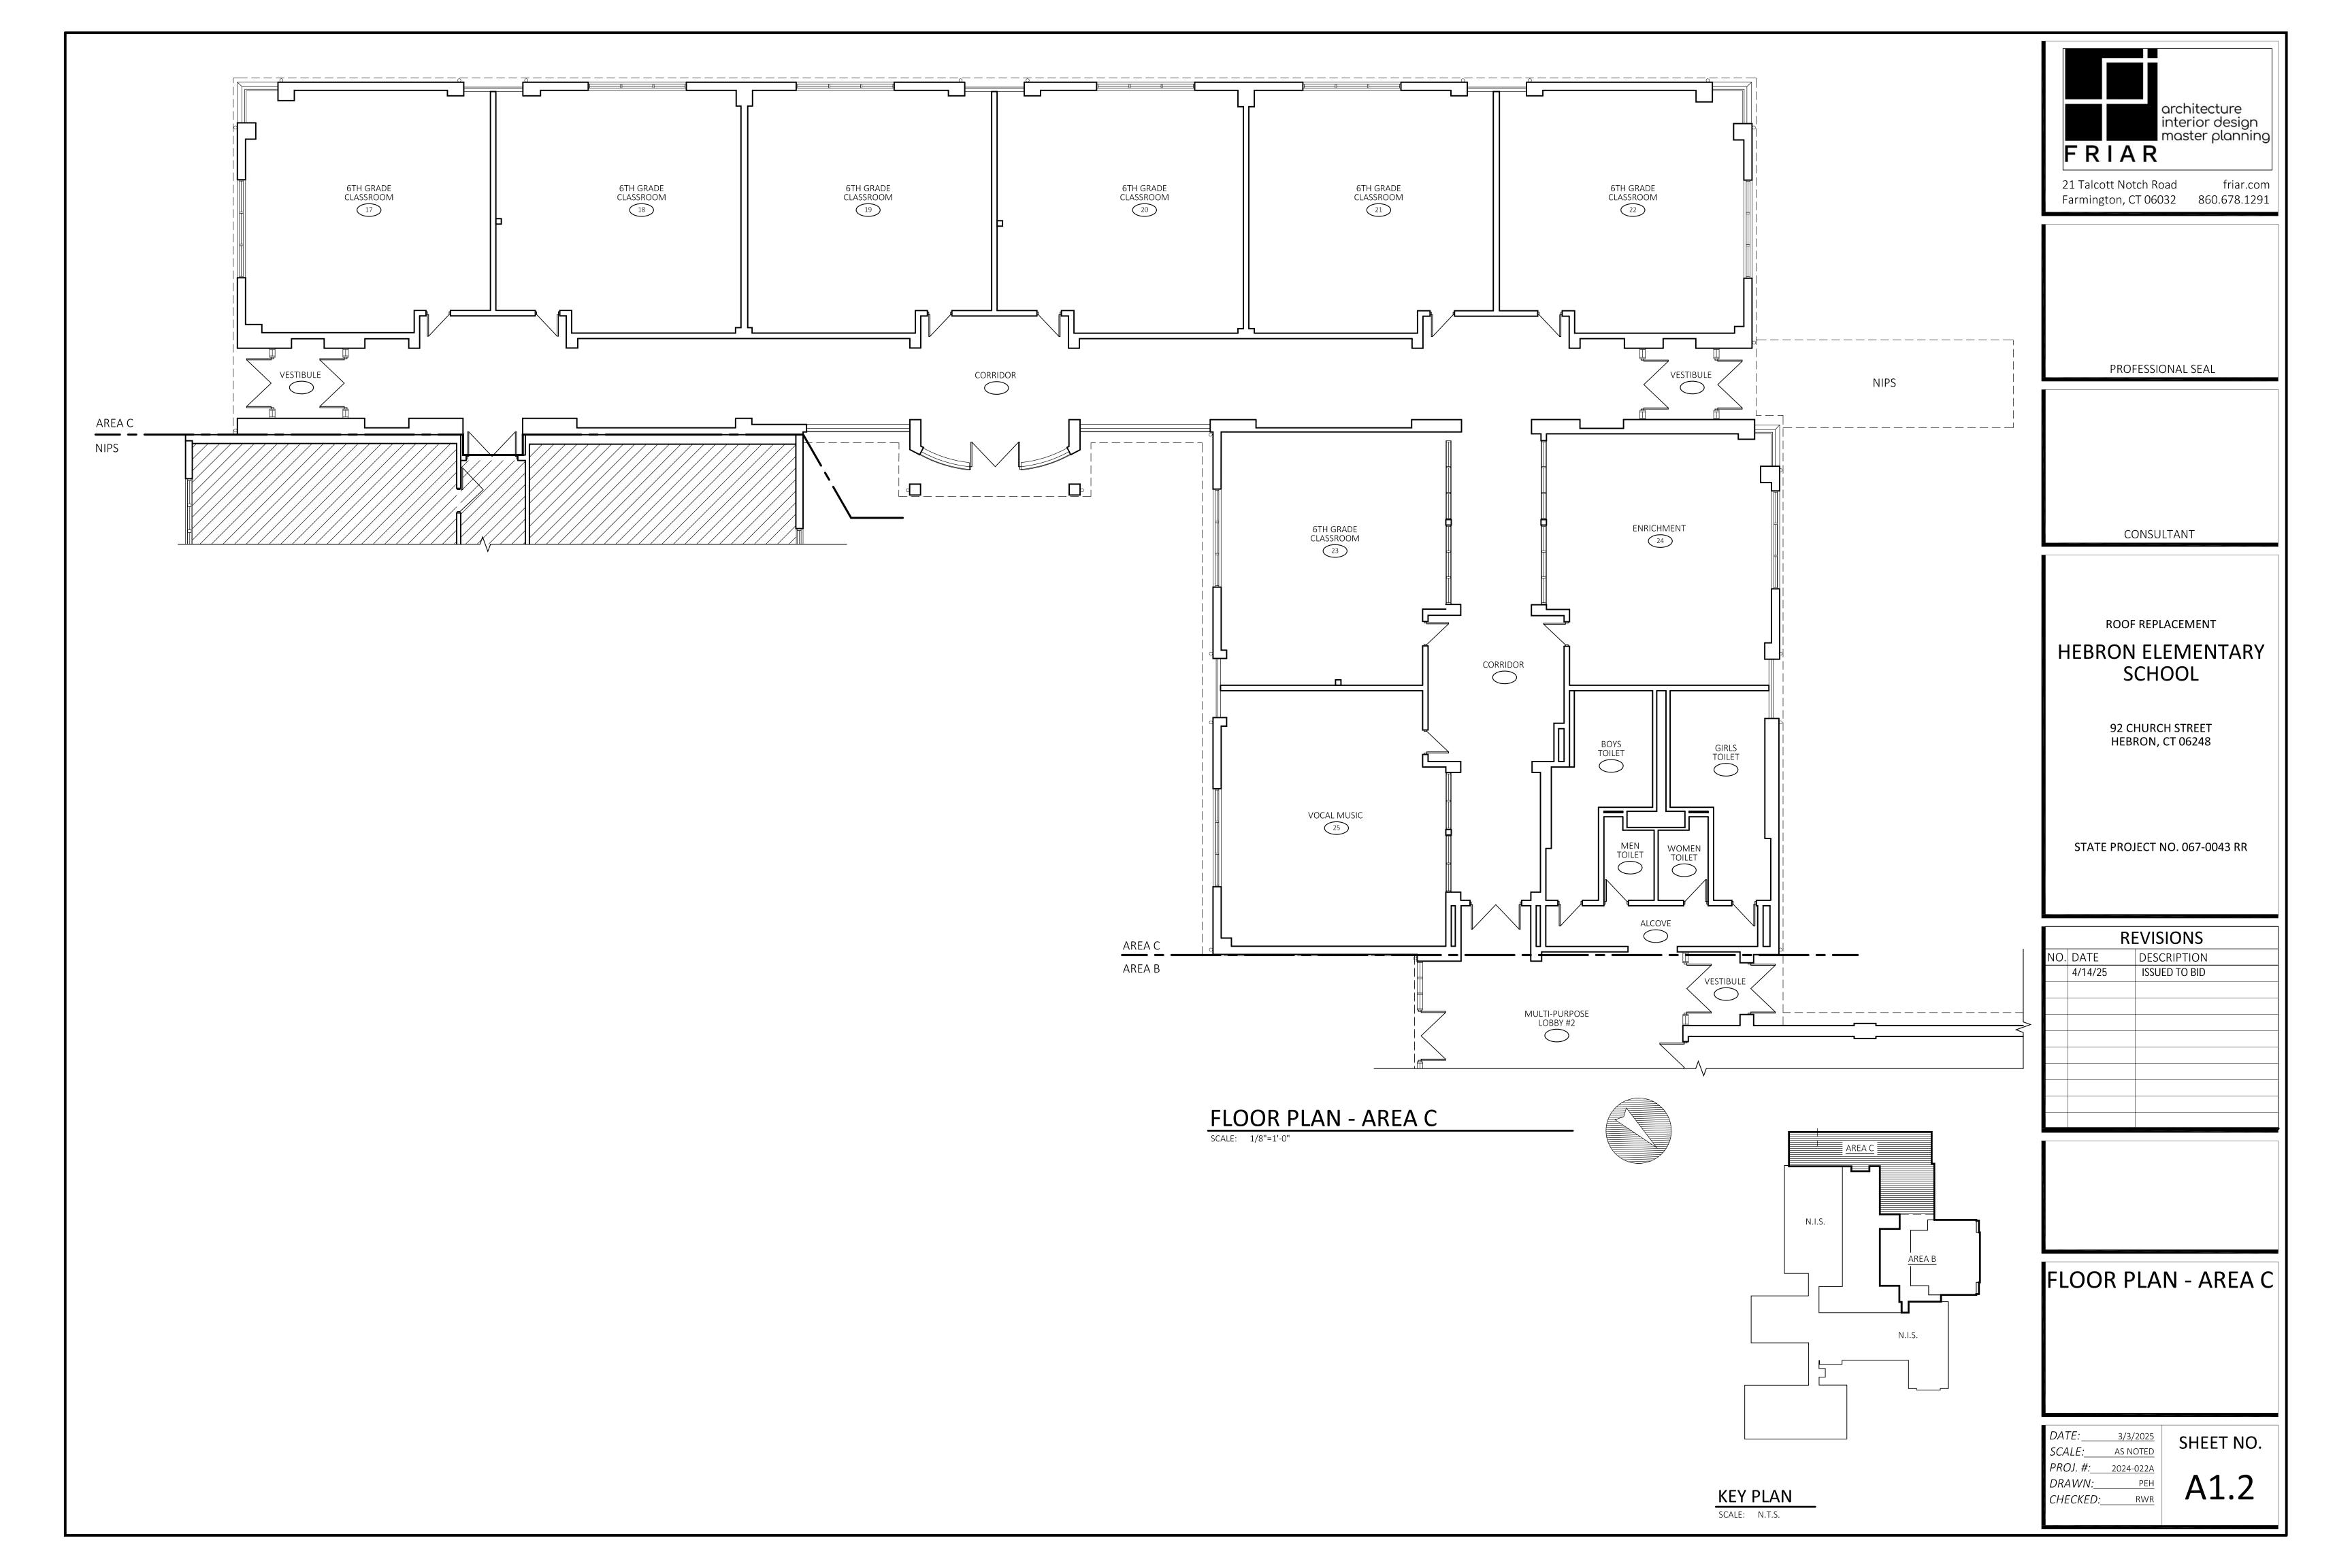
DEMO ROOF PLAN AREA B - AREA C





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	CHECKED:	RWF
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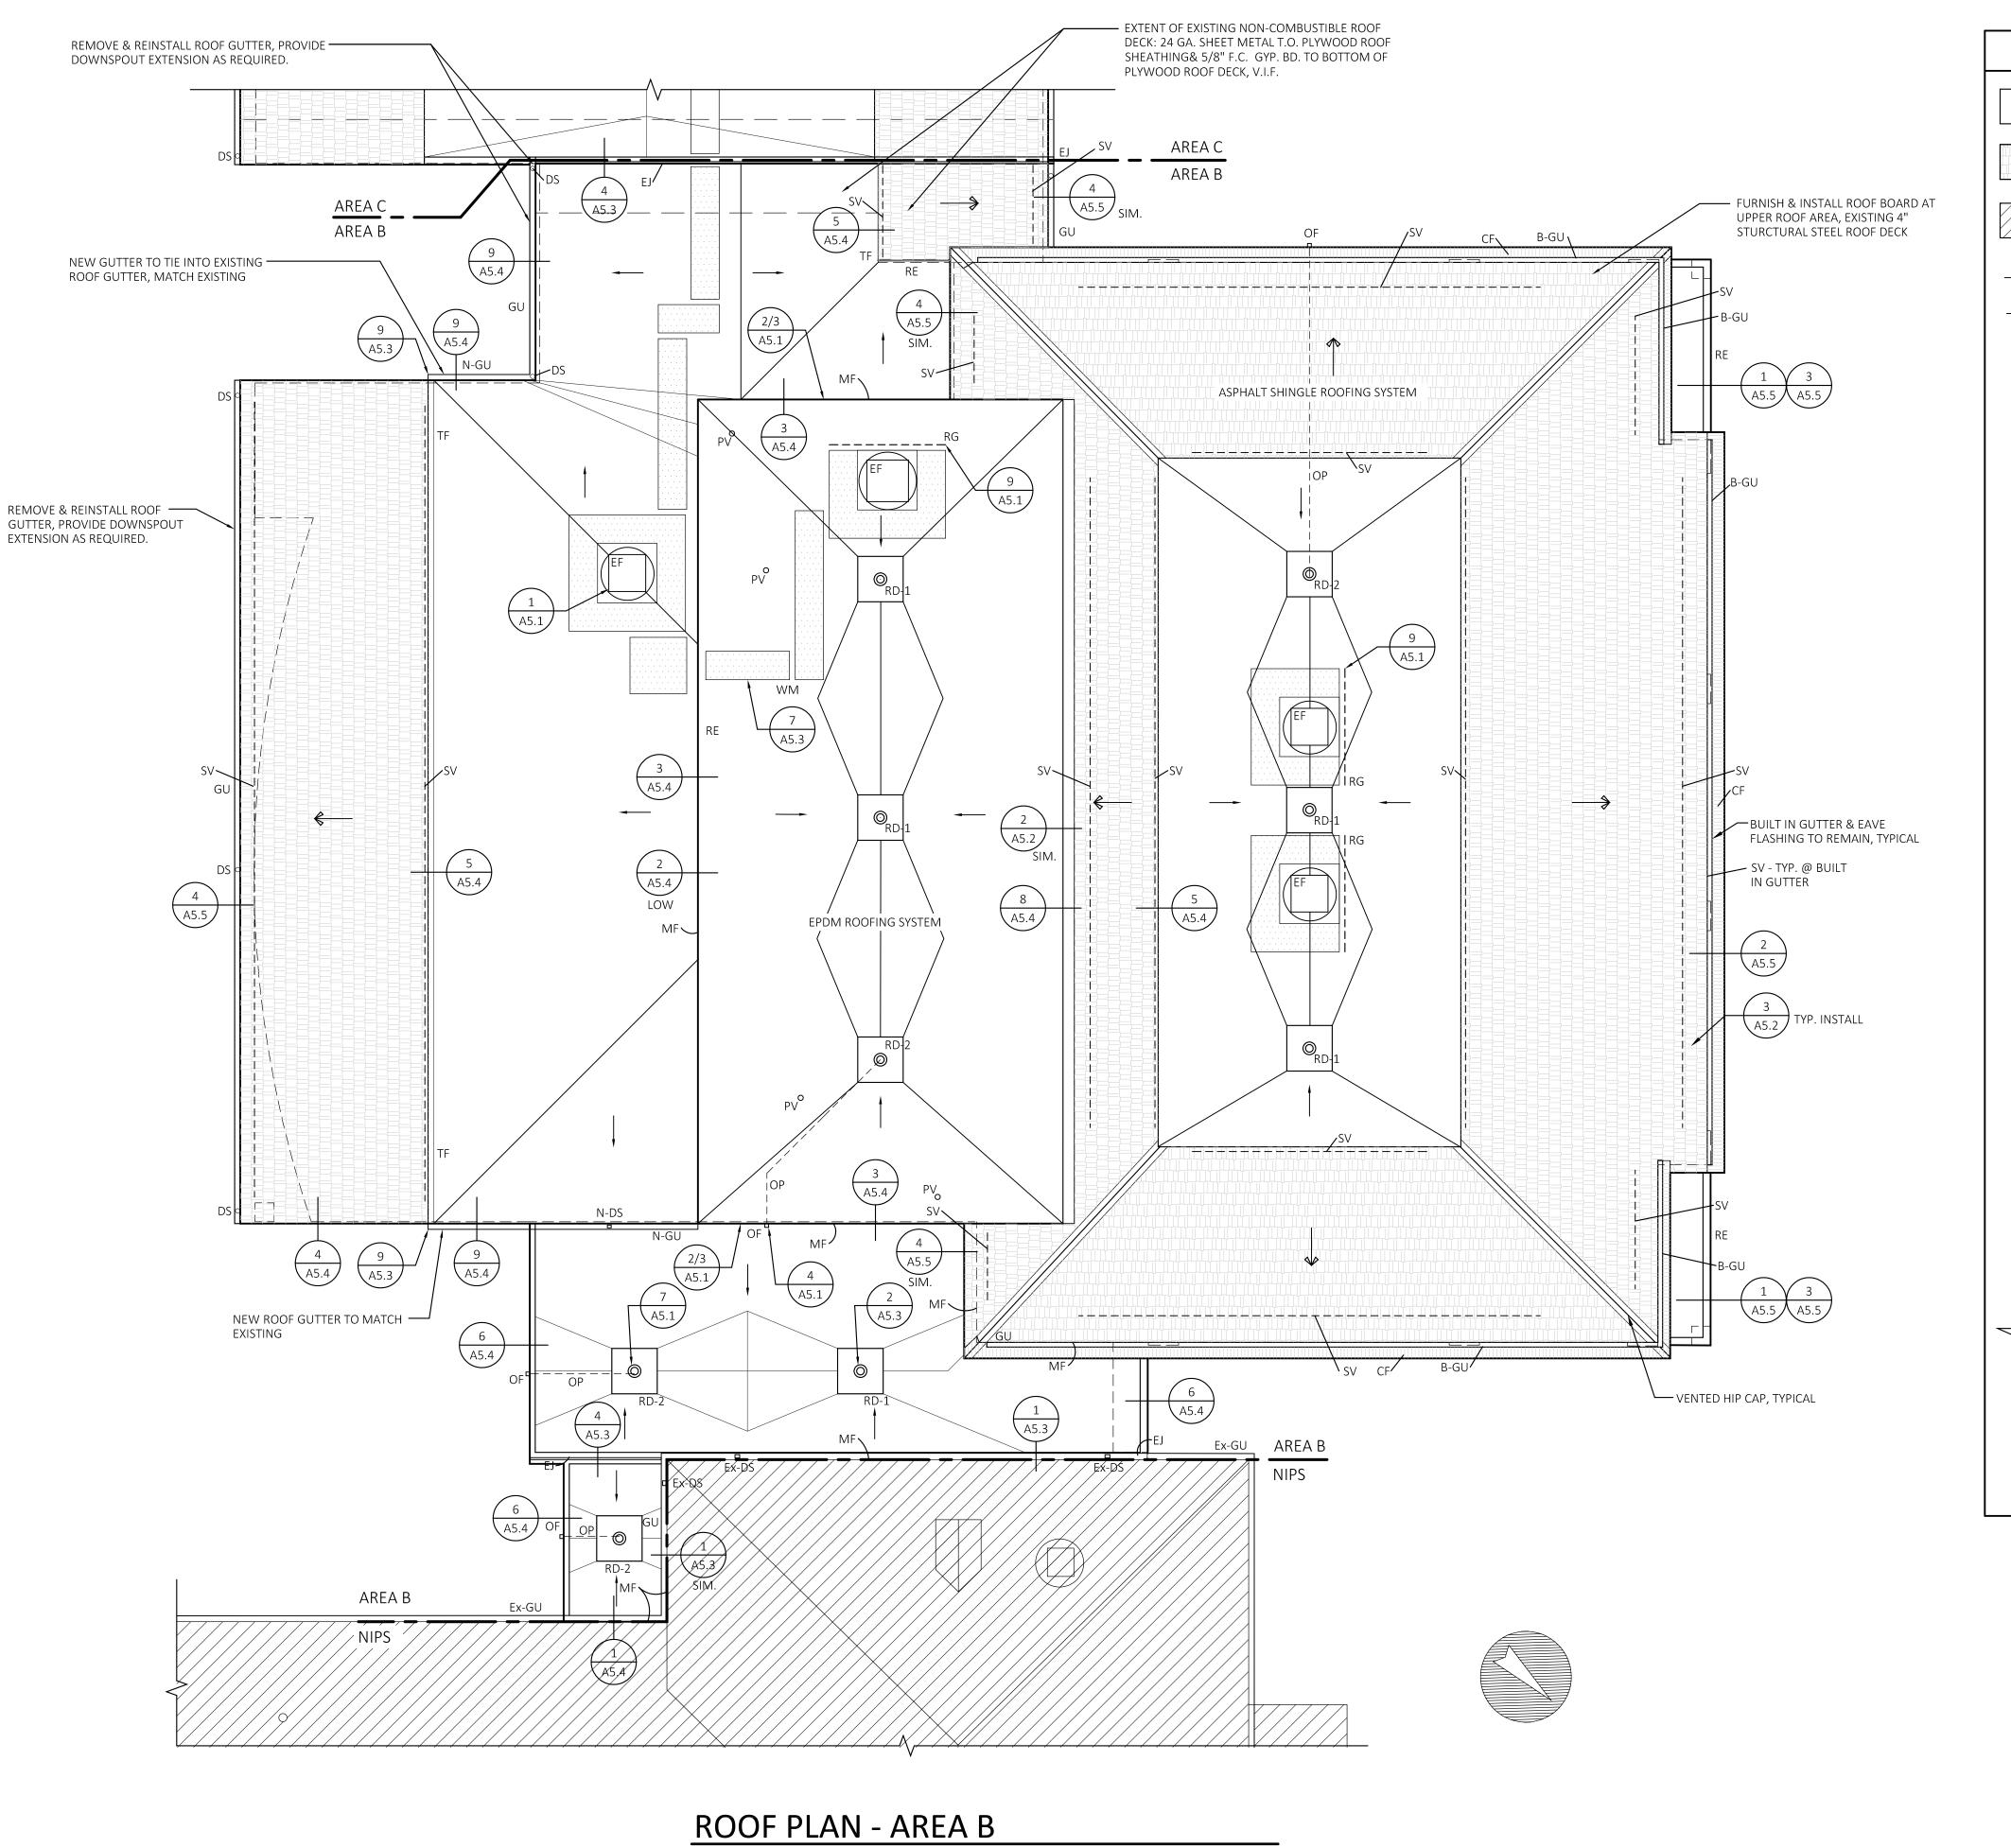
SHEET NO. D1.1







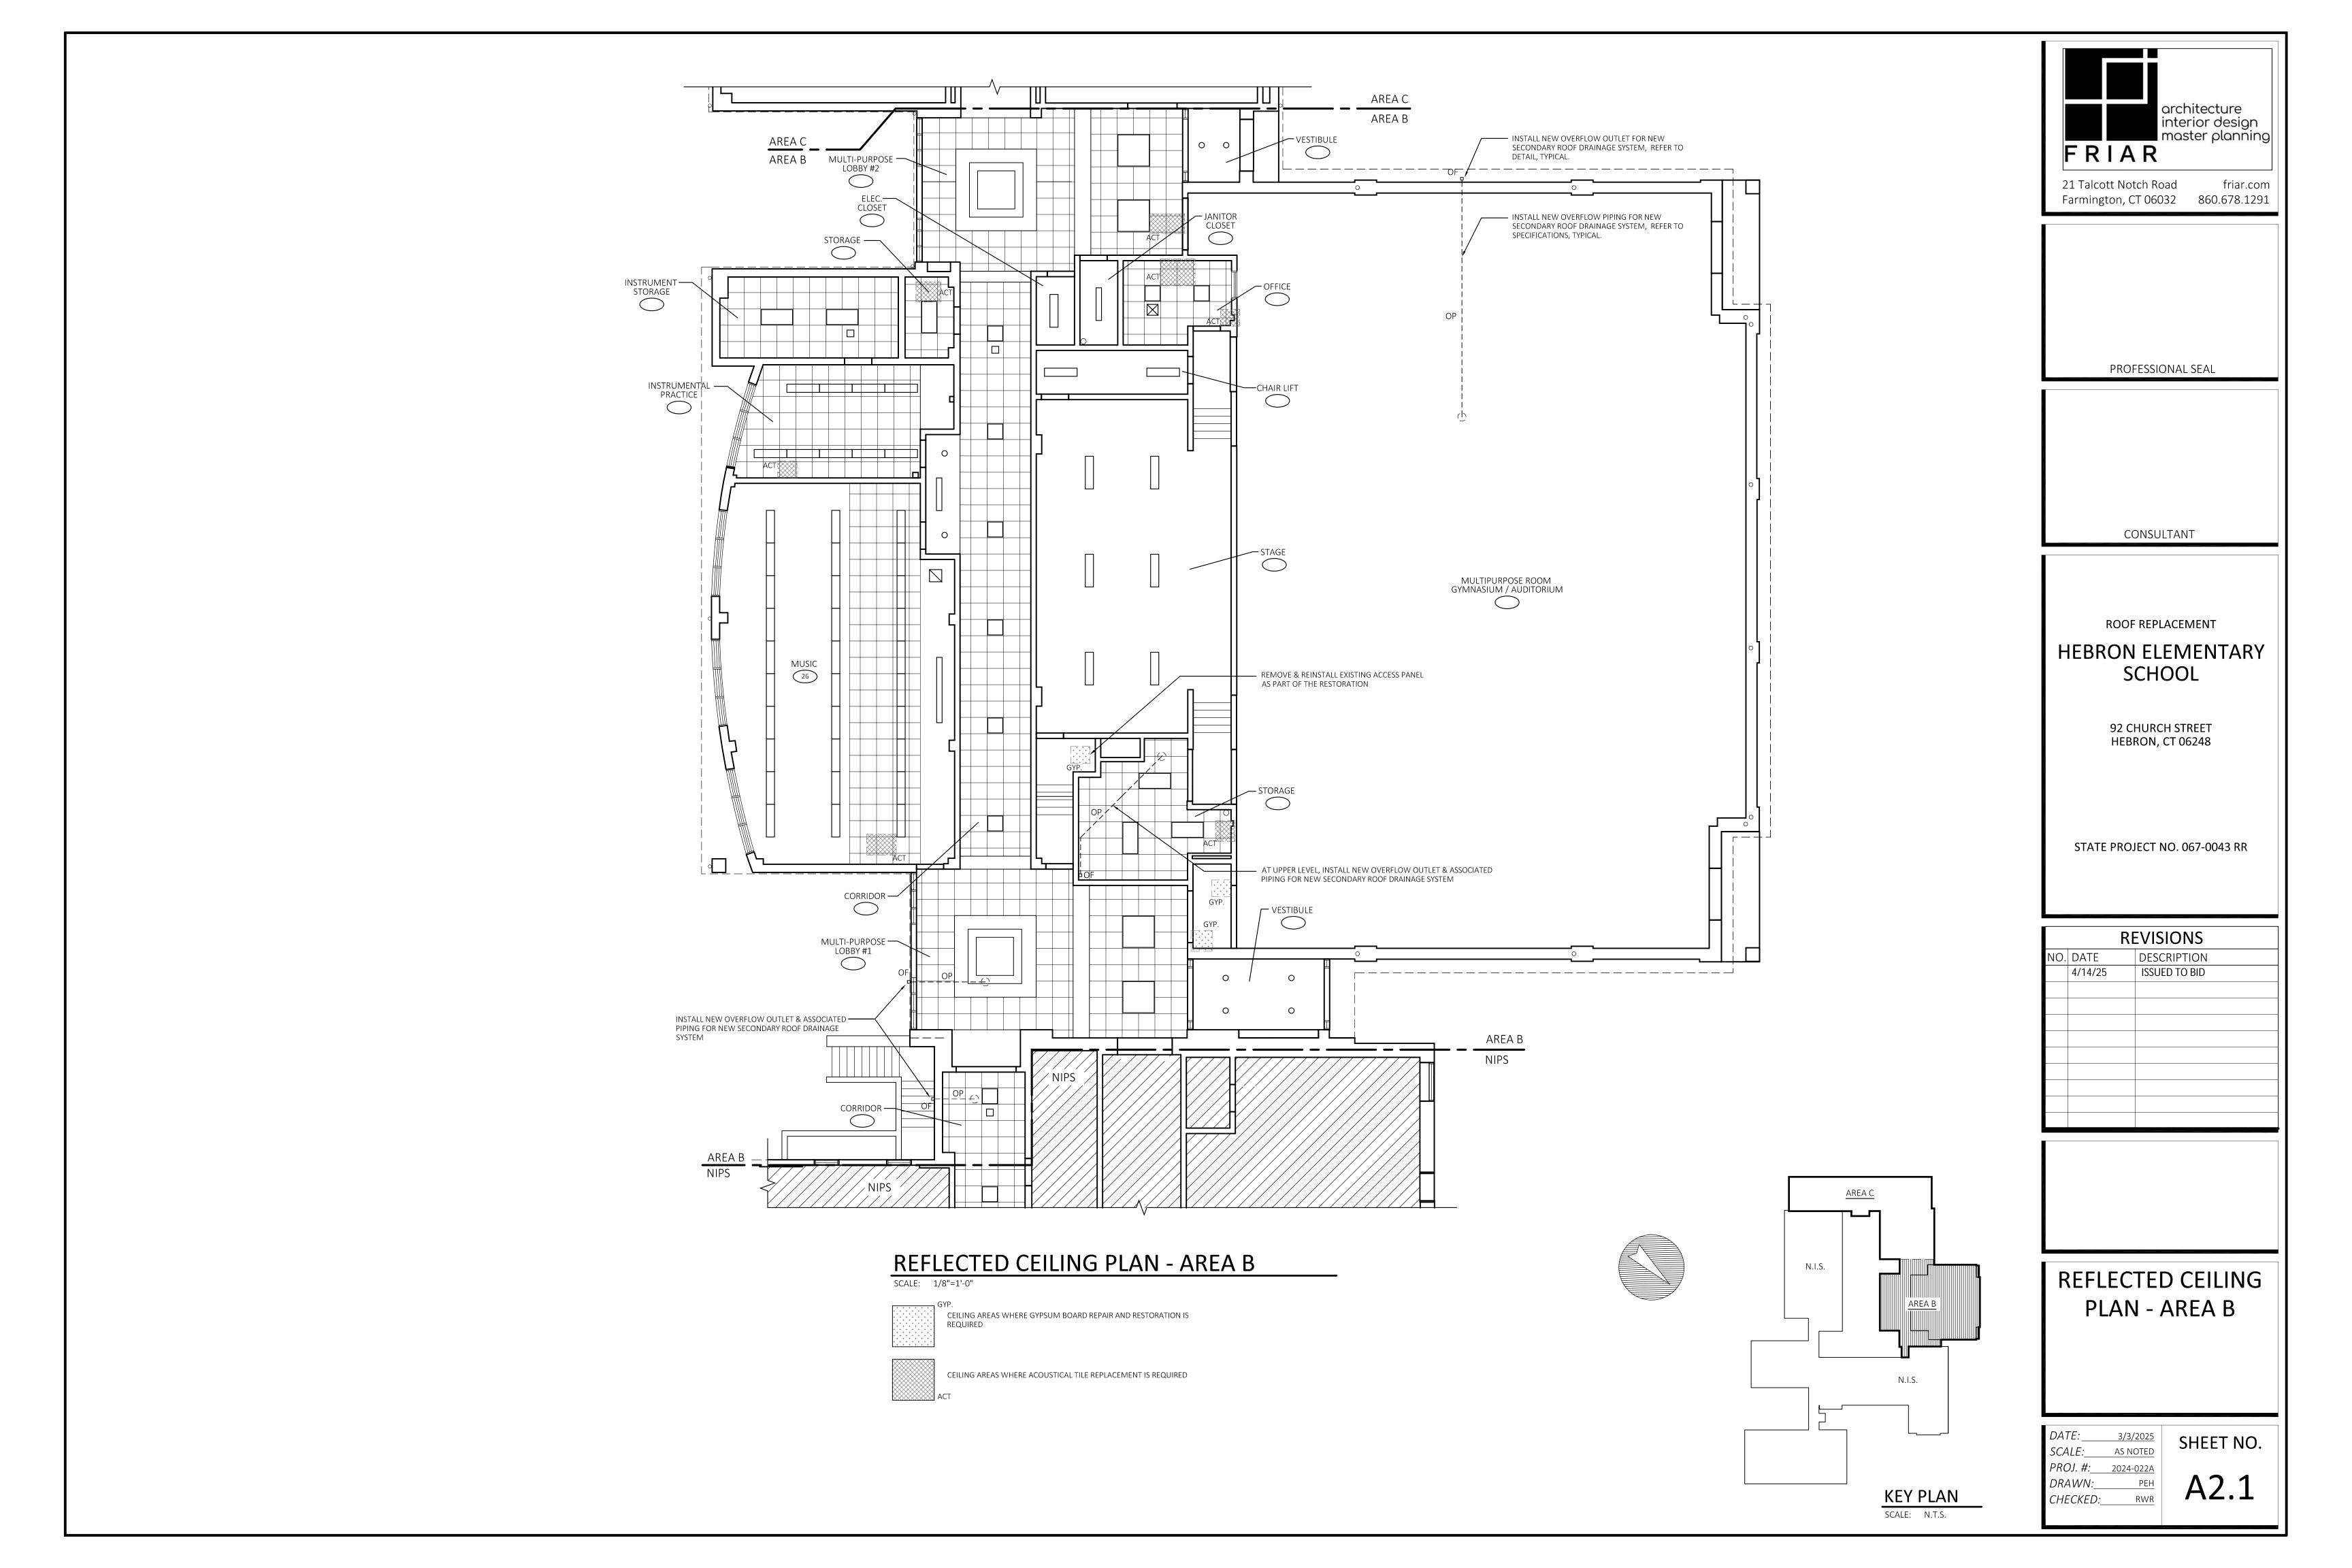

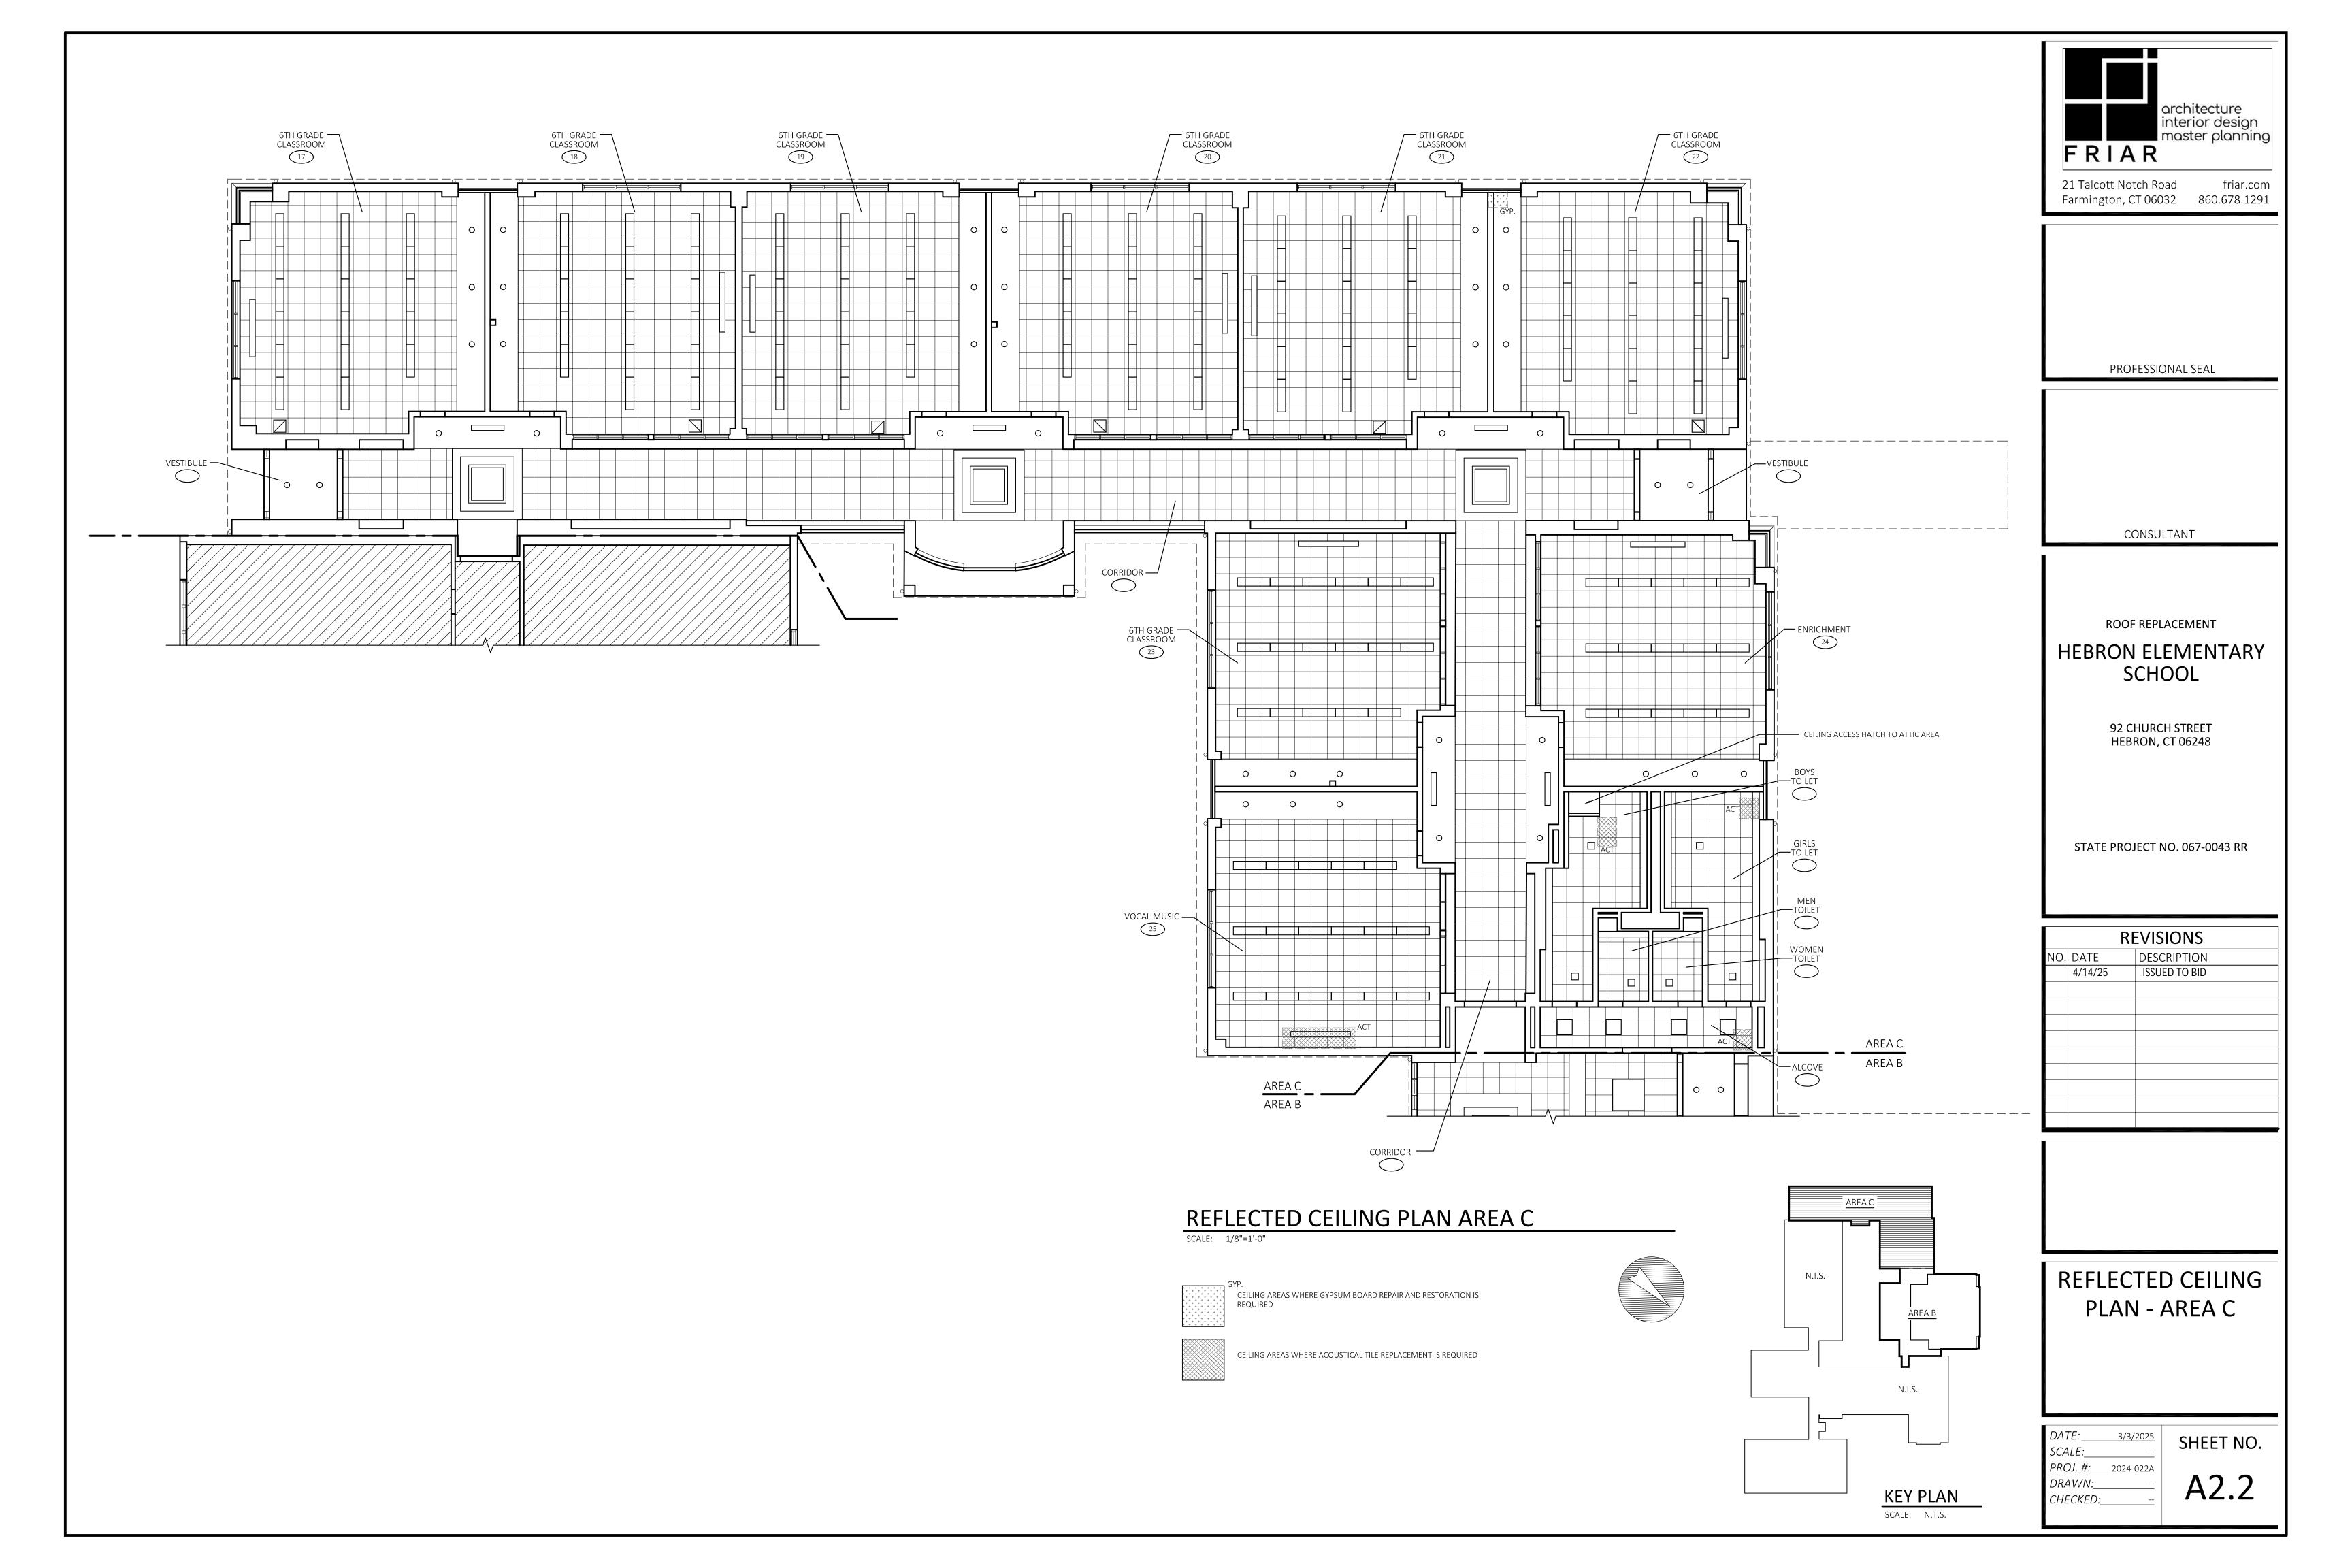



NEW EPDM SINGLE PLY ROOF SYSTEM



NEW ASPHALT SHINGLE ROOFING SYSTEM AREA B (VENTED ROOF SHINGLE SYSTEM) AREA C (NON - VENTED ROOF SHINGLE SYSTEM)



ROOF AREAS DESIGNATED AS NOT IN PROJECT SCOPE (N.I.S.)



NEW TAPERED INSULATION - ROOF PITCH



NEW ROOF DRAIN, REFER TO PLUMBING SPECIFICATIONS FOR ROOF DRAIN. INSTALL ASSOCIATED STORM PIPING, PIPING CONNECTIONS & CLEANOUTS AS REQUIRED FOR RECONNECTION TO EXISTING STORM PIPING, TYPICAL.

NEW ROOF DRAIN, REFER TO PLUMBING SPECIFICATIONS FOR BI-FUNCTIONAL ROOF DRAIN. INSTALL ASSOCIATED STORM PIPING, PIPING CONNECTIONS & CLEANOUTS AS REQUIRED FOR RECONNECTION TO EXISTING STORM PIPING & NEW SECONDARY

PLUMBING VENT TO REMAIN, NEW ROOF SYSTEM FLASHING, REFER TO DETAIL, TYPICAL.

EXISTING EQUIPMENT DUNNAGE TO REMAIN. NEW ROOF FLASHING & FILL, REFER TO

EXISTING DOWNSPOUT TO REMAIN. AT ALL LOCATIONS PROVIDE SPLASH BLOCK & PROTECTIVE MEMBRANE, TYPICAL

NEW DOWNSPOUT, AT ALL LOCATIONS PROVIDE SPLASH BLOCK & PROTECTIVE MEMBRANE, TYPICAL

EXISTING DOWNSPOUT, NOT IN PROJECT SCOPE

ROOF TOP UNIT TO REMAIN, REMOVE EXISTING CURB FLASHING FOR INSTALLATION OF NEW CURB FLASHING, TYPICAL.

EXISTING ROOF LADDER TO REMAIN

INSTALL NEW EQUIPMENT CURB / SUPPORT & ASSOCIATED ROOF FLASHING SYSTEM FOR NEW ROOF, REFER TO DETAIL, TYPICAL.

EXHAUST FAN TO REMAIN, NEW CURB FLASHING, REFER TO DETAIL, TYPICAL.

NEW PIPE PENETRATION & FLASHING, REFER TO DETAIL, TYPICAL.

EXISTING GUTTER, ROOF EDGE FLASHING / GUTTER, REFER TO DETAIL, TYPICAL.

NEW GUTTER / ROOF EDGE FLASHING, REFER TO DETAIL, TYPICAL.

Ex-GU EXISTING GUTTER, NOT IN PROJECT SCOPE

INSTALL NEW ROOF FLASHING & METAL COUNTER FLASHING, REFER TO DETAIL, TYPICAL.

INSTALL NEW METAL ROOF EDGE AS REQUIRED FOR ALL NEW WORK, REFER TO DETAIL,

INSTALL NEW ROOF EXPANSION JOINT SYSTEMS AS REQUIRED FOR ALL NEW WORK,

INSTALL NEW OVERFLOW OUTLET FOR NEW SECONDARY ROOF DRAINAGE SYSTEM, REFER TO DETAIL, TYPICAL.

N.I.S.

N.I.S.

KEY PLAN

SCALE: N.T.S.

INSTALL NEW OVERFLOW PIPING FOR NEW SECONDARY ROOF DRAINAGE SYSTEM, REFER TO SPECIFICATIONS, TYPICAL.

INSTALL NEW TRANSITIONAL METAL FLASHING AT ASPHALT SHINGLES / EPDM ROOFING

INTERSECTION, REFER TO DETAIL, TYPICAL. INSTALL NEW WALK MATS AT LOCATIONS SHOWN, REFER TO DETAIL, TYPICAL.

COPPER FLASHING TO REMAIN, TYPICAL

BUILT-IN COPPER GUTTER TO REMAIN, TYPICAL

NEW PREFABRICATED ASPHALT SHINGLE AIR VENT, TYPICAL

EXISTING ROOF PITCH, VERIFY IN FIELD



21 Talcott Notch Road friar.com Farmington, CT 06032 860.678.1291

PROFESSIONAL SEAL

CONSULTANT

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	4/14/25	ISSUED TO BID

ROOF PLAN - AREA B


SCALE:\_ AS NOTED *PROJ. #:* 2024-022A


CHECKED:\_


SHEET NO. DRAWN:\_


RWR

REFER TO SHEET NO. A3.2 ROOF PLAN AREA C FOR CONSTRUCTION

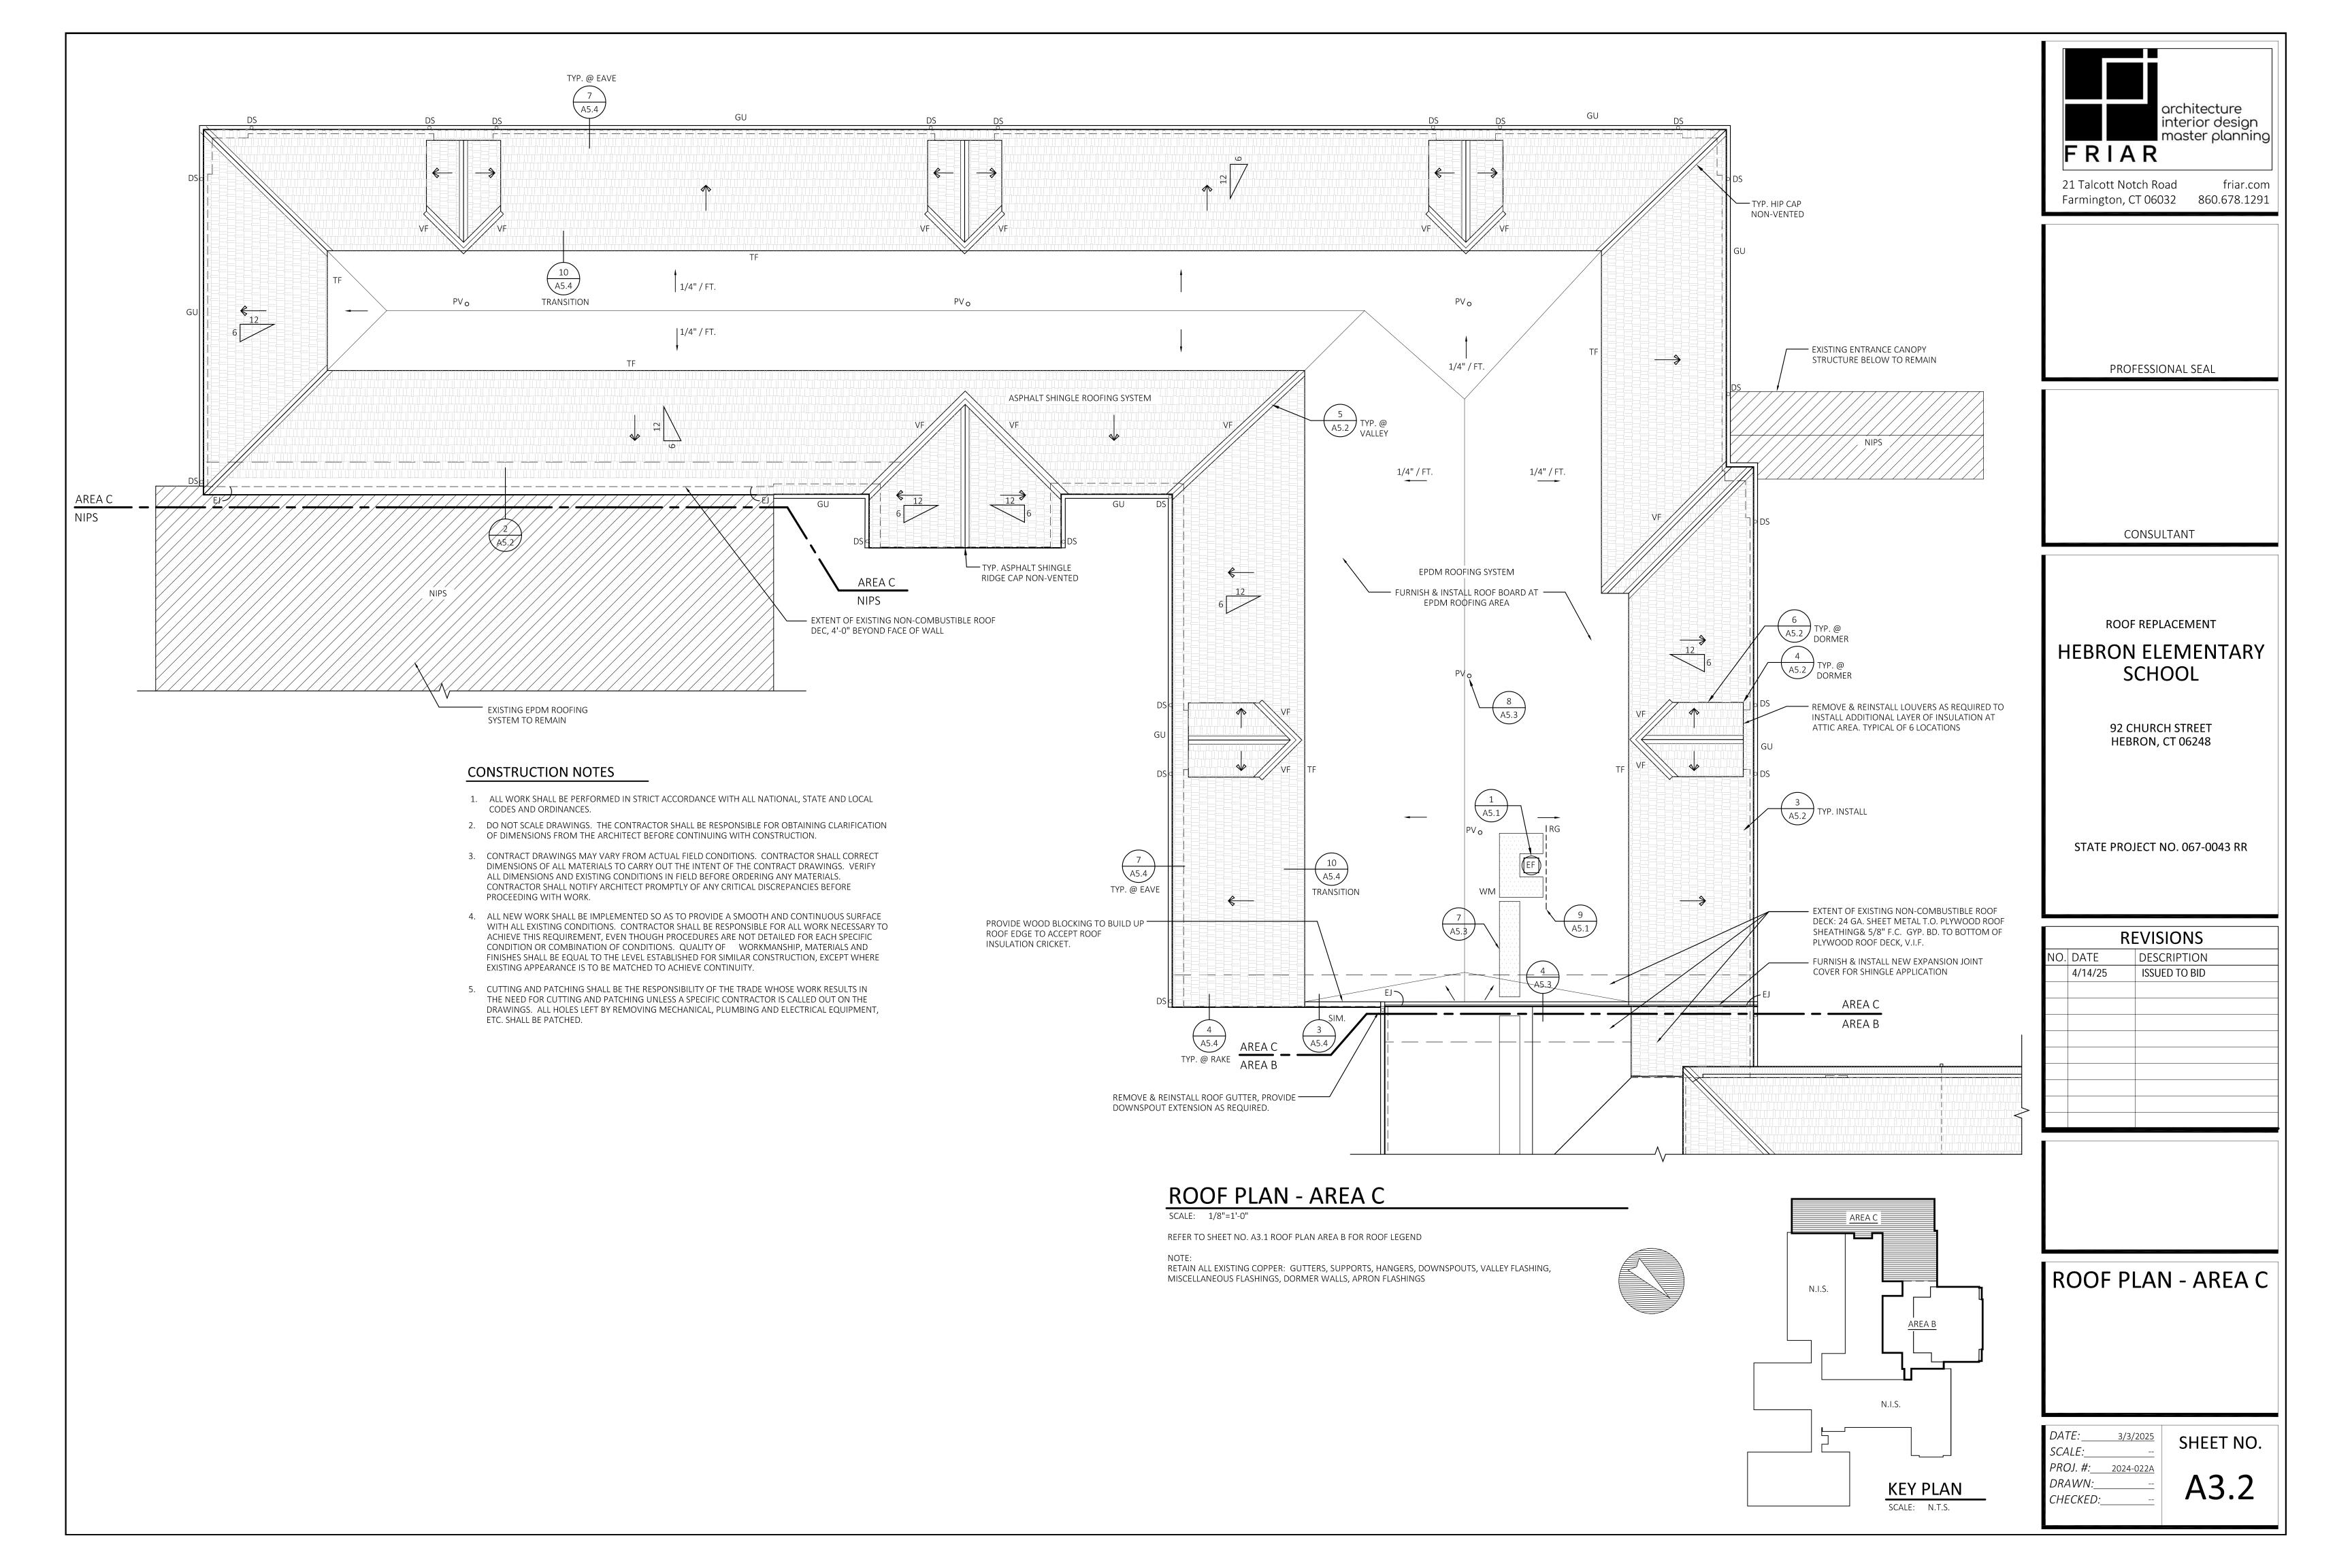

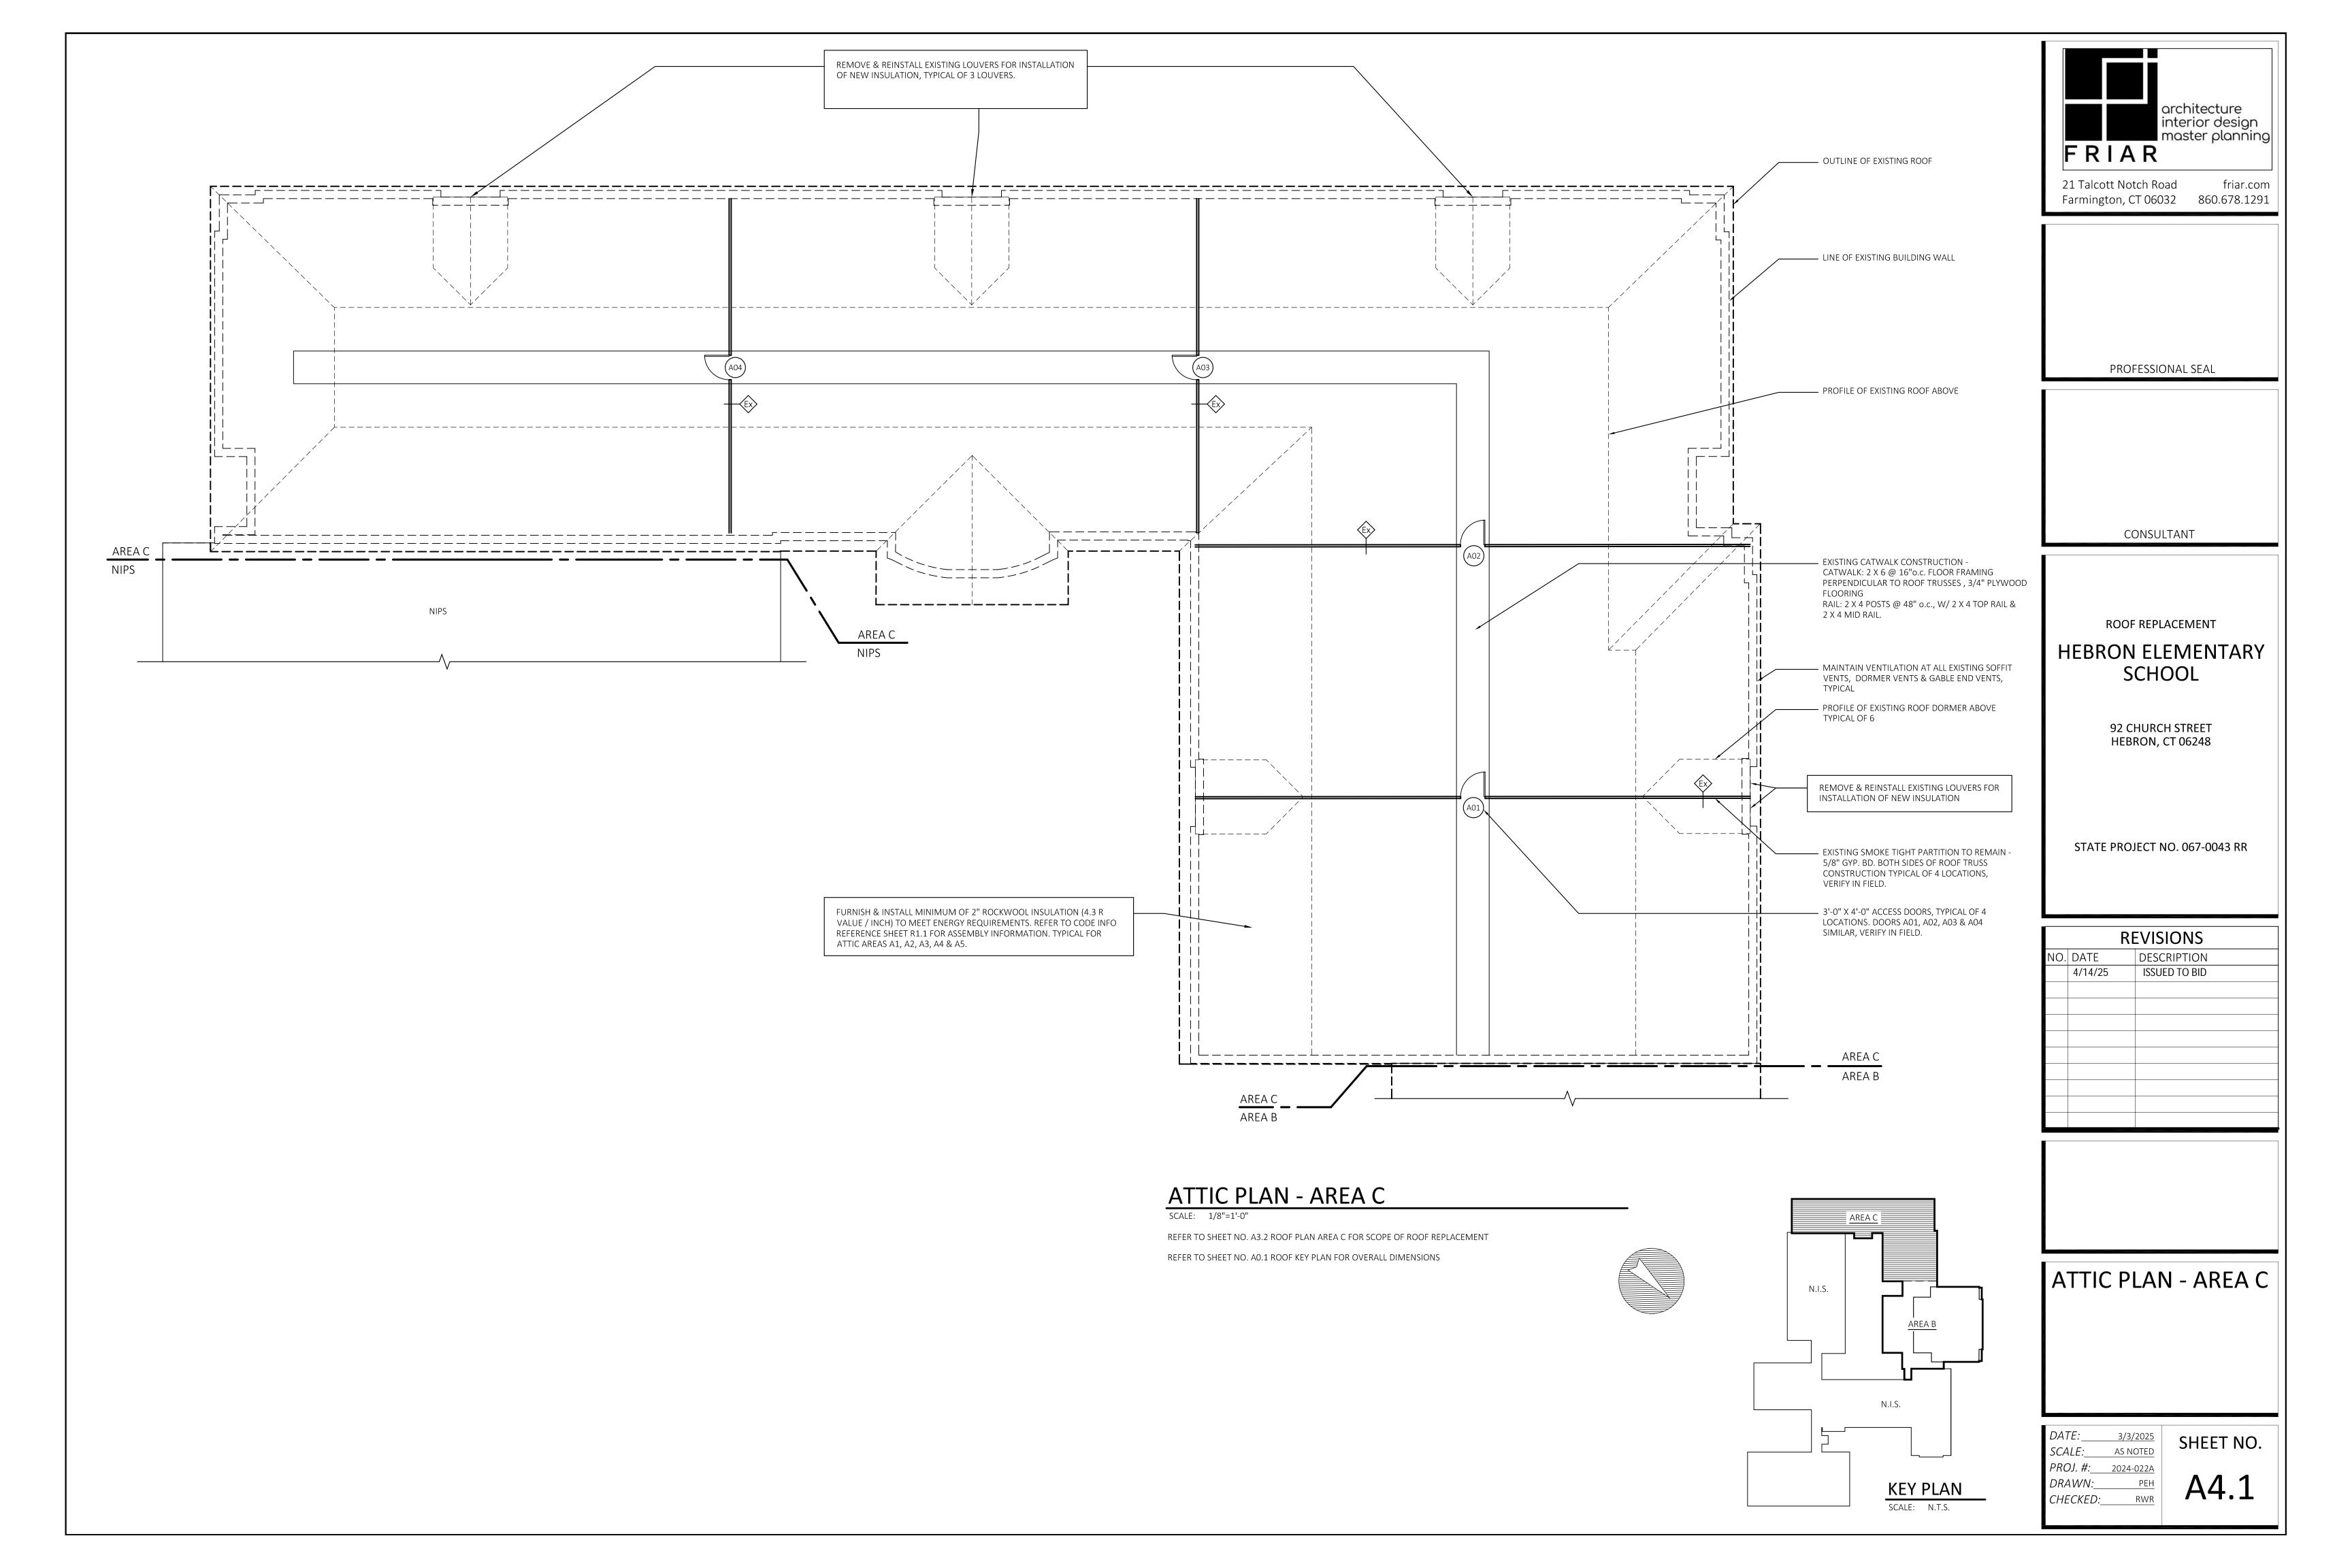


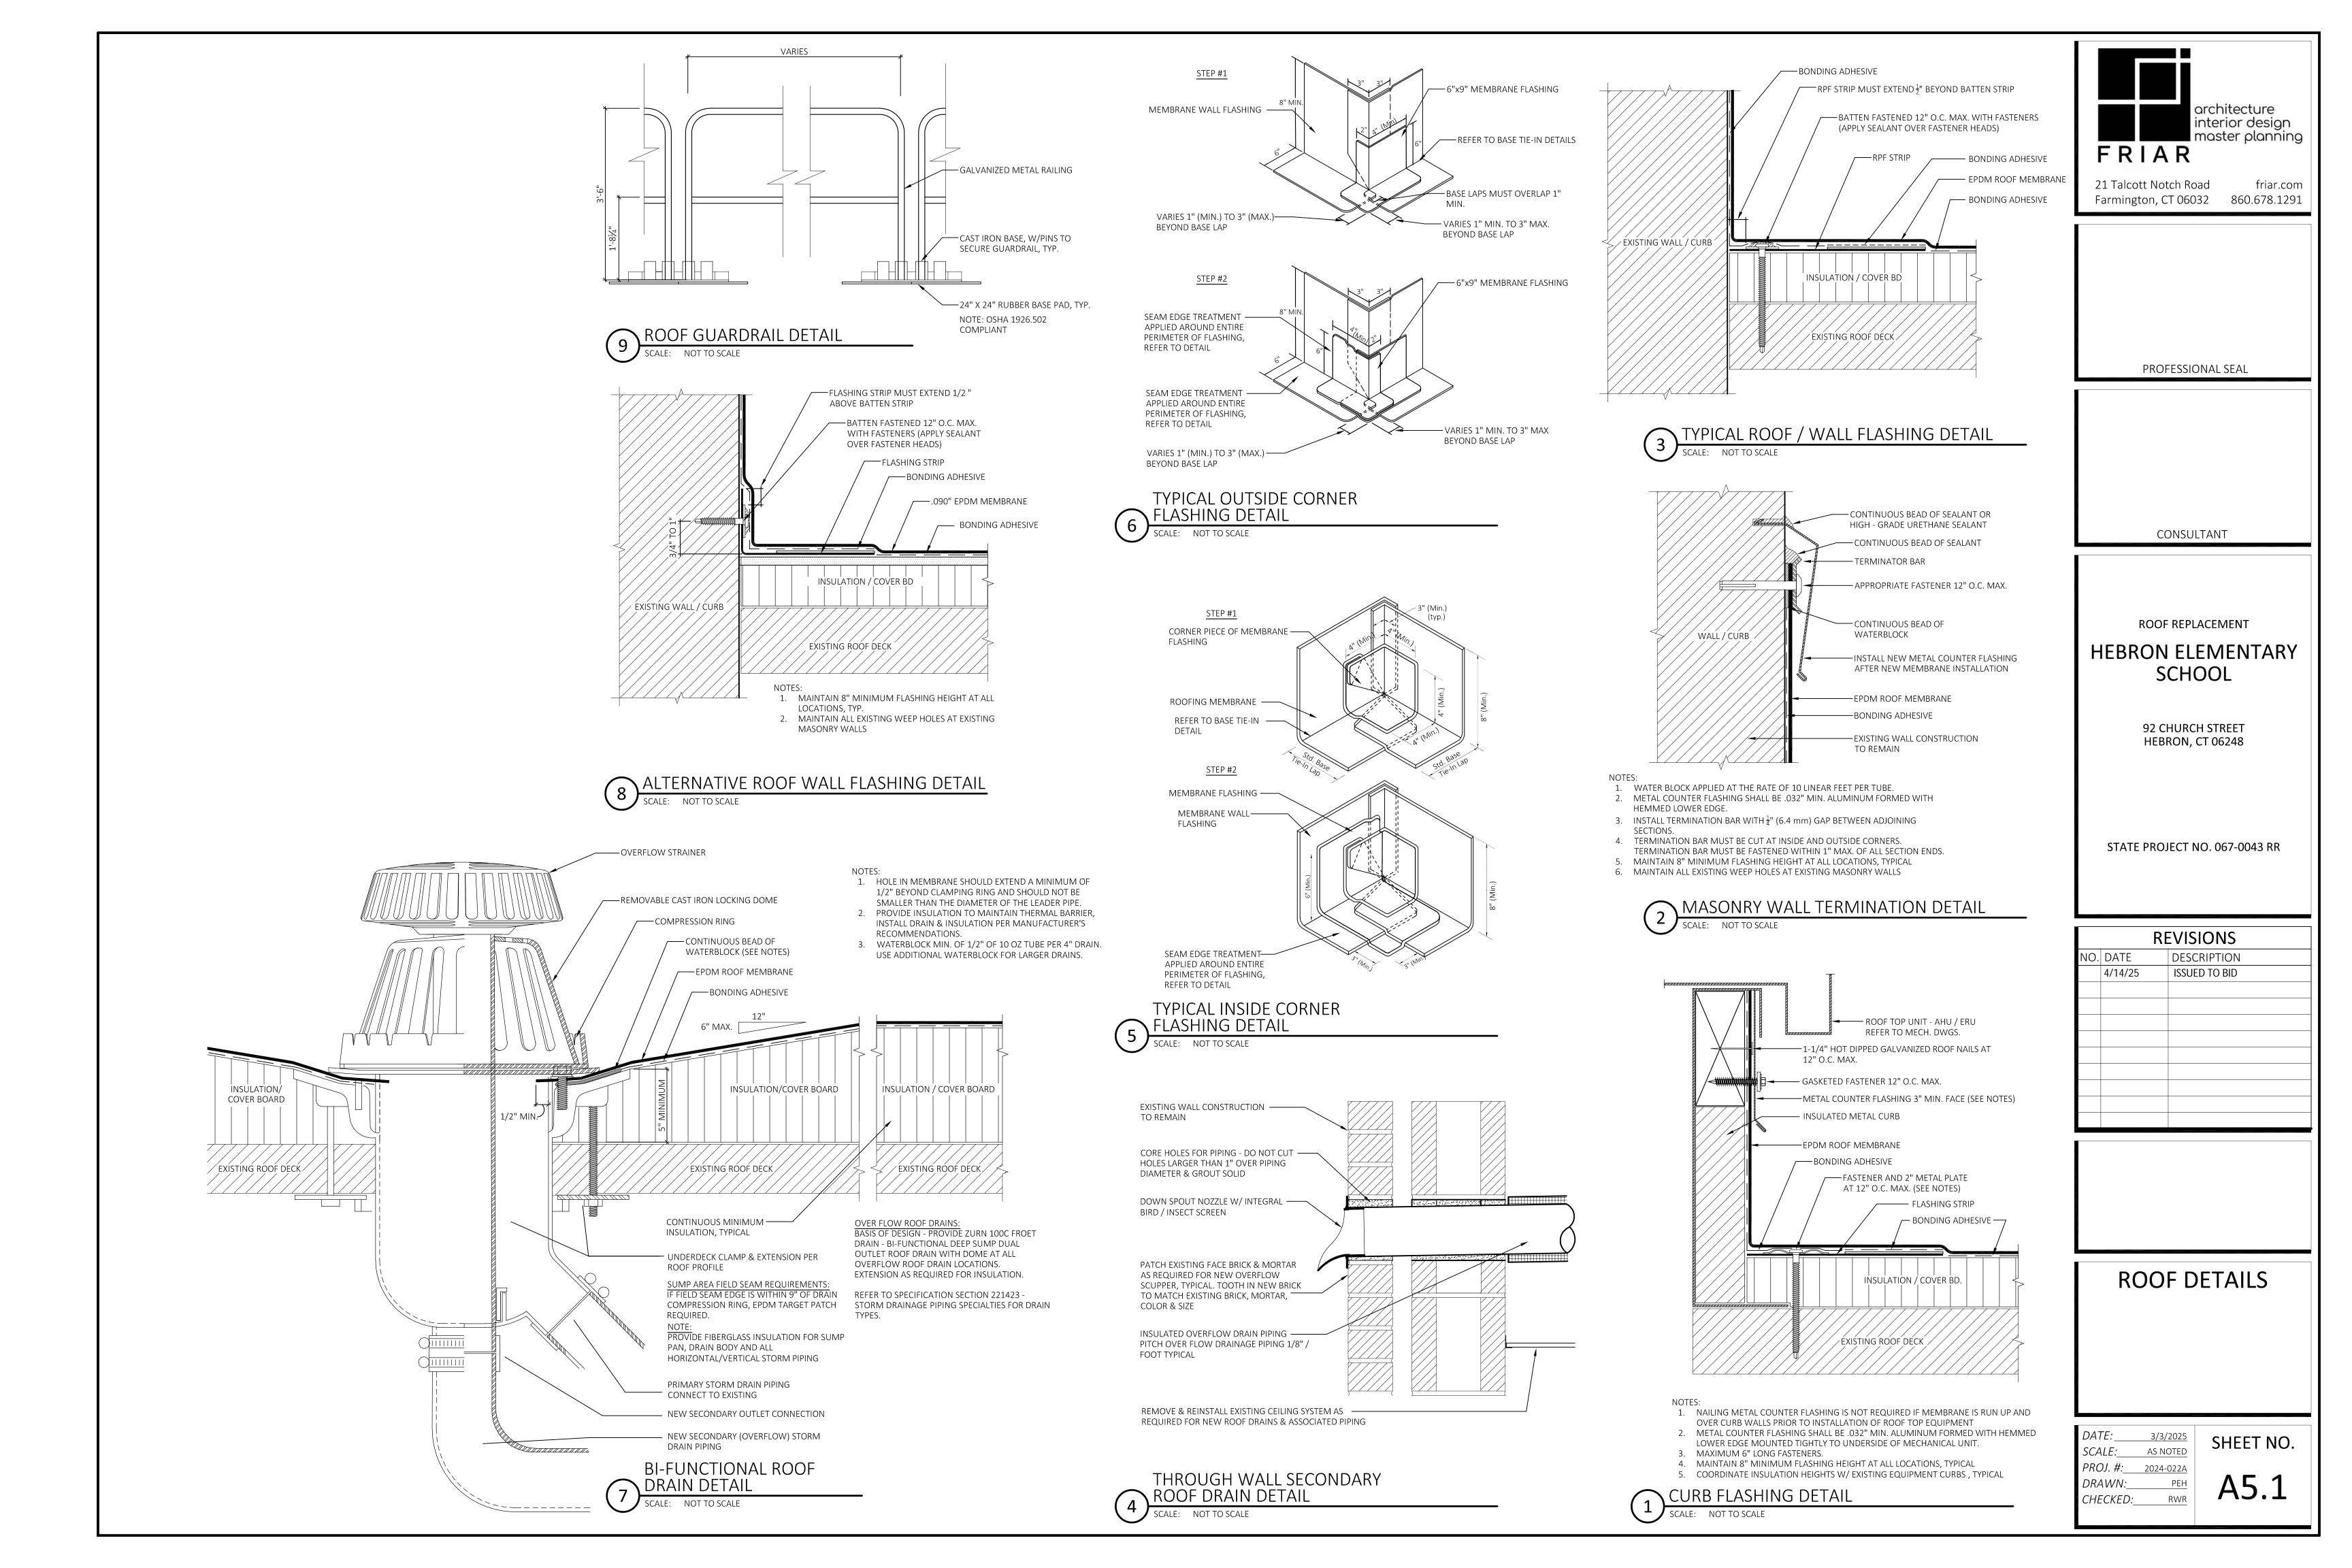

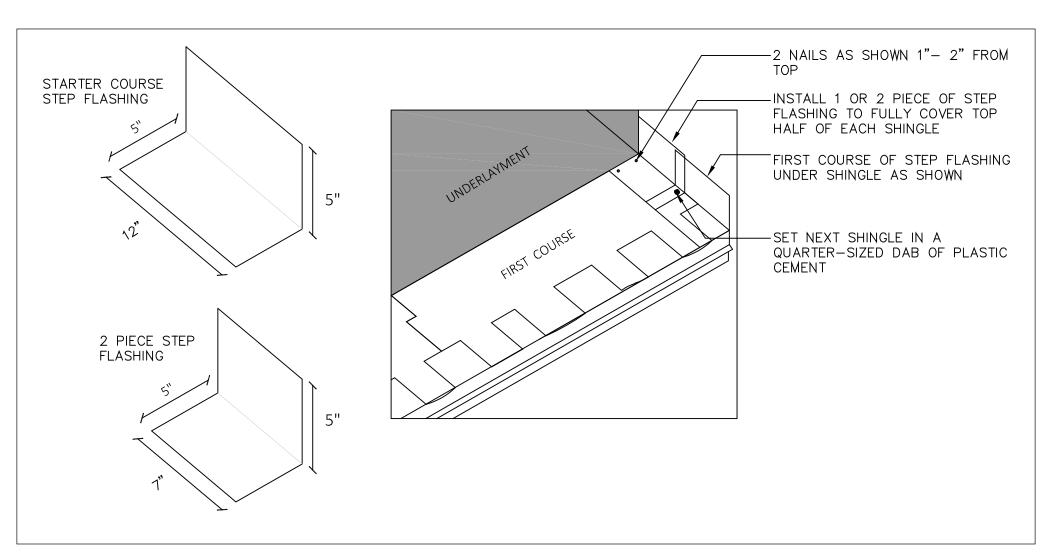


STEP FLASHING DETAIL

SCALE: NOT TO SCALE

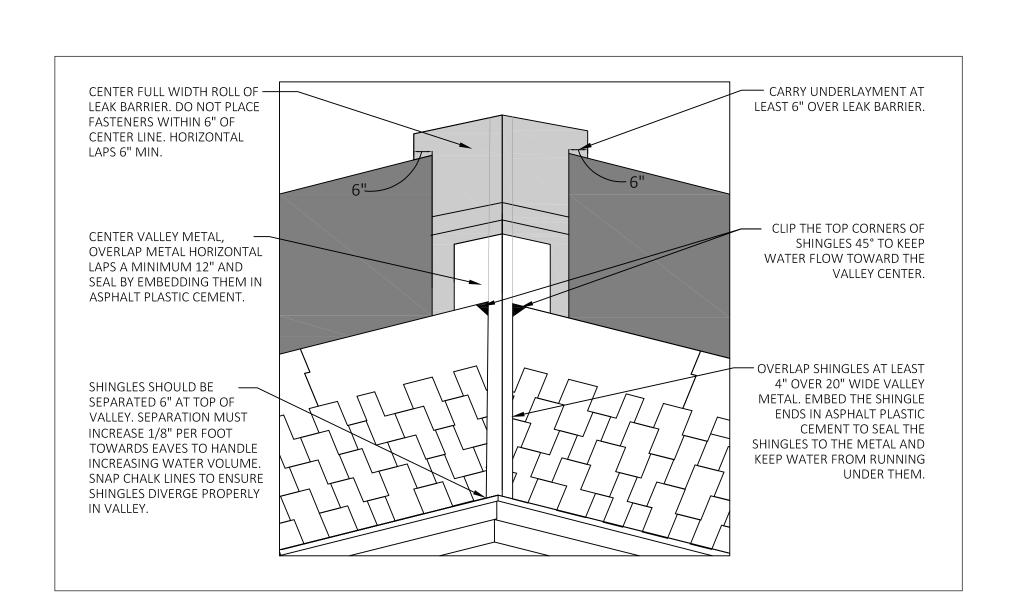


OPEN VALLEY DETAIL

SCALE: NOT TO SCALE

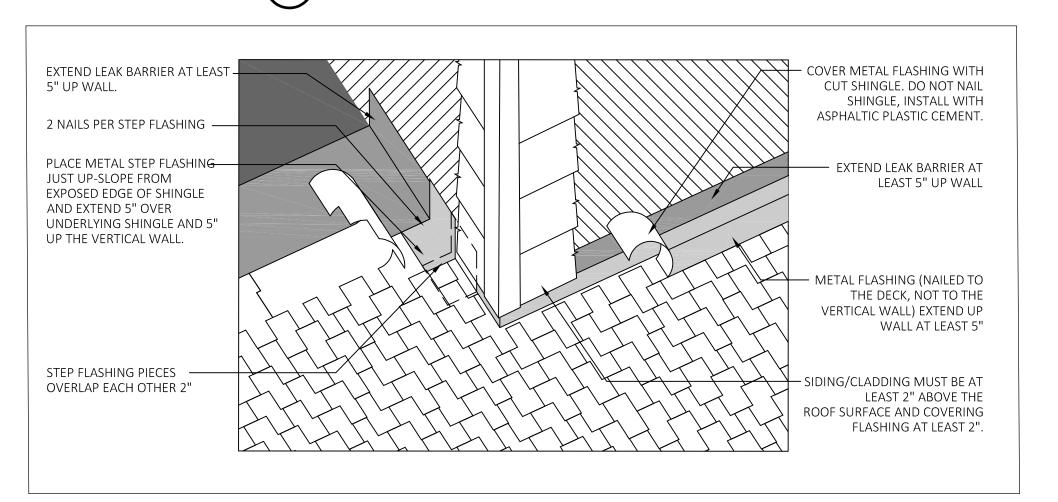


WALL FLASHING DETAIL

SCALE: NOT TO SCALE

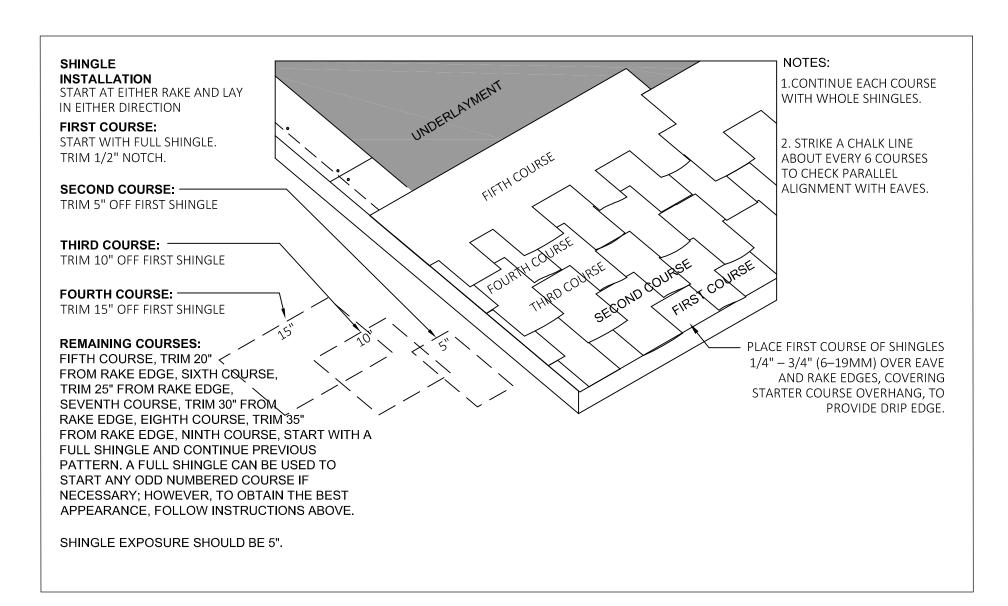


SHINGLE INSTALL DETAIL

SCALE: NOT TO SCALE

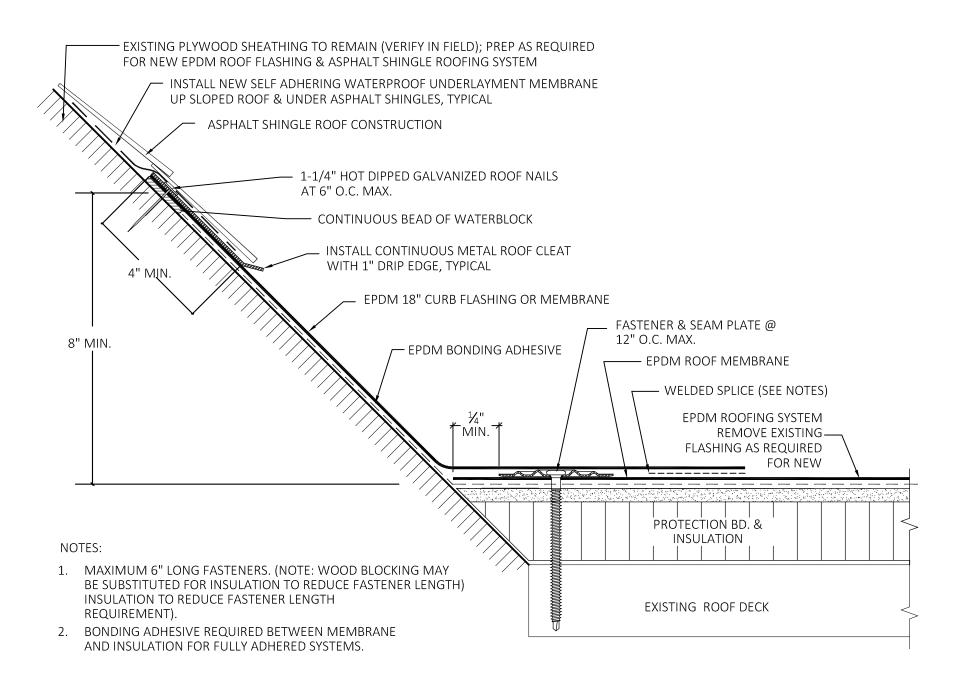

TRANSITION FLASHING DETAIL AT SHINGLE / EPDM ROOFING SYSTEM

SCALE: NOT TO SCALE

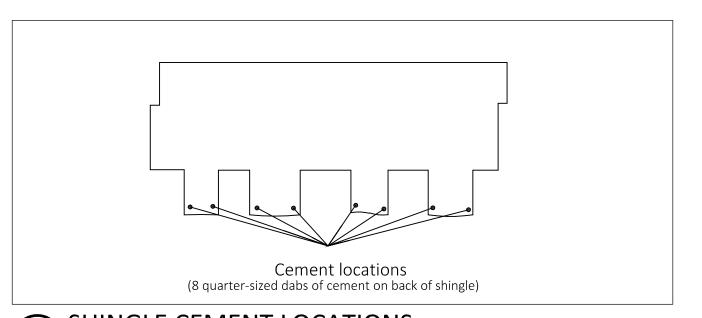

SHINGLE CEMENT LOCATIONS

SCALE: NOT TO SCALE



ROOF REPLACEMENT

CONSULTANT

## HEBRON ELEMENTARY SCHOOL

92 CHURCH STREET HEBRON, CT 06248

STATE PROJECT NO. 067-0043 RR

	REVISIONS					
NO.	DATE	DESCRIPTION				
	4/14/25	ISSUED TO BID				
_						

**ROOF DETAILS** 

 DATE:
 3/3/2025

 SCALE:
 AS NOTED

 PROJ. #:
 2024-022A

 DRAWN:
 PEH

 CHECKED:
 RWR

A5.2

SHEET NO.

